CITYWIDE PEDESTRIAN SAFETY IMPROVEMENTS

FEDERAL WAY, WA PROJECT # 36234

PROJECT TEAM:

CITY OF FEDERAL WAY 33325 8TH AVE S FEDERAL WAY, WA 98003 CONTACT: JEFF HUYNH, PE

PHONE: 253.835.2721 EMAIL: JEFF.HUYNH@CITYOFFEDERALWAY.COM

CIVIL ENGINEER 2106 PACIFIC AVENUE. SUITE 300

TACOMA, WA 98402 CONTACT: SHANNON PODGORSKI, PE PHONE: 253.627.4367 EMAIL: SPODGORSKI@BCRADESIGN.COM **RRFB AND ILLUMINATION DESIGN**

PH CONSULTING 913 MLK JR WAY, SUITE A TACOMA, WA 98405 CONTACT: PABLO PARA, PE PHONE: 208.310.6077 EMAIL: PABLO@PHTRAFFIC.COM

SURVEYOR LANKTREE LAND SURVEYING, INC.

421 "B" STREET NE **AUBURN, WA 98002** CONTACT: TREVOR LANKTREE PHONE: 253.653.6423 EMAIL: TLANKTREE@LANKTREELAND.COM

SURVEY DATUM:


BASIS NAD83(2011) DATUM PER WASHINGTON STATE REFERENCE

NETWORK(WSRN)

BASIS NAD83(2011) DATUM WAS ESTABLISHED BY HOLDING WSRN OBSERVATIONS ON MONUMENTS, SAID DIMENSIONS AS SHOWN ON SURVEY.

VERTICAL DATUM (NGVD29)

NATIONAL GEODETIC VERTICAL DATUM OF 1929 (NGVD29) BASED ON CITY OF FEDERAL WAY SURVEY CONTROL MONUMENT FW-101, BEING A MONUMENT IN CASE AT THE INTERSECTION OF SW 320TH ST. AND 8TH AVE. S. ELEVATION: 421.83 FEET.

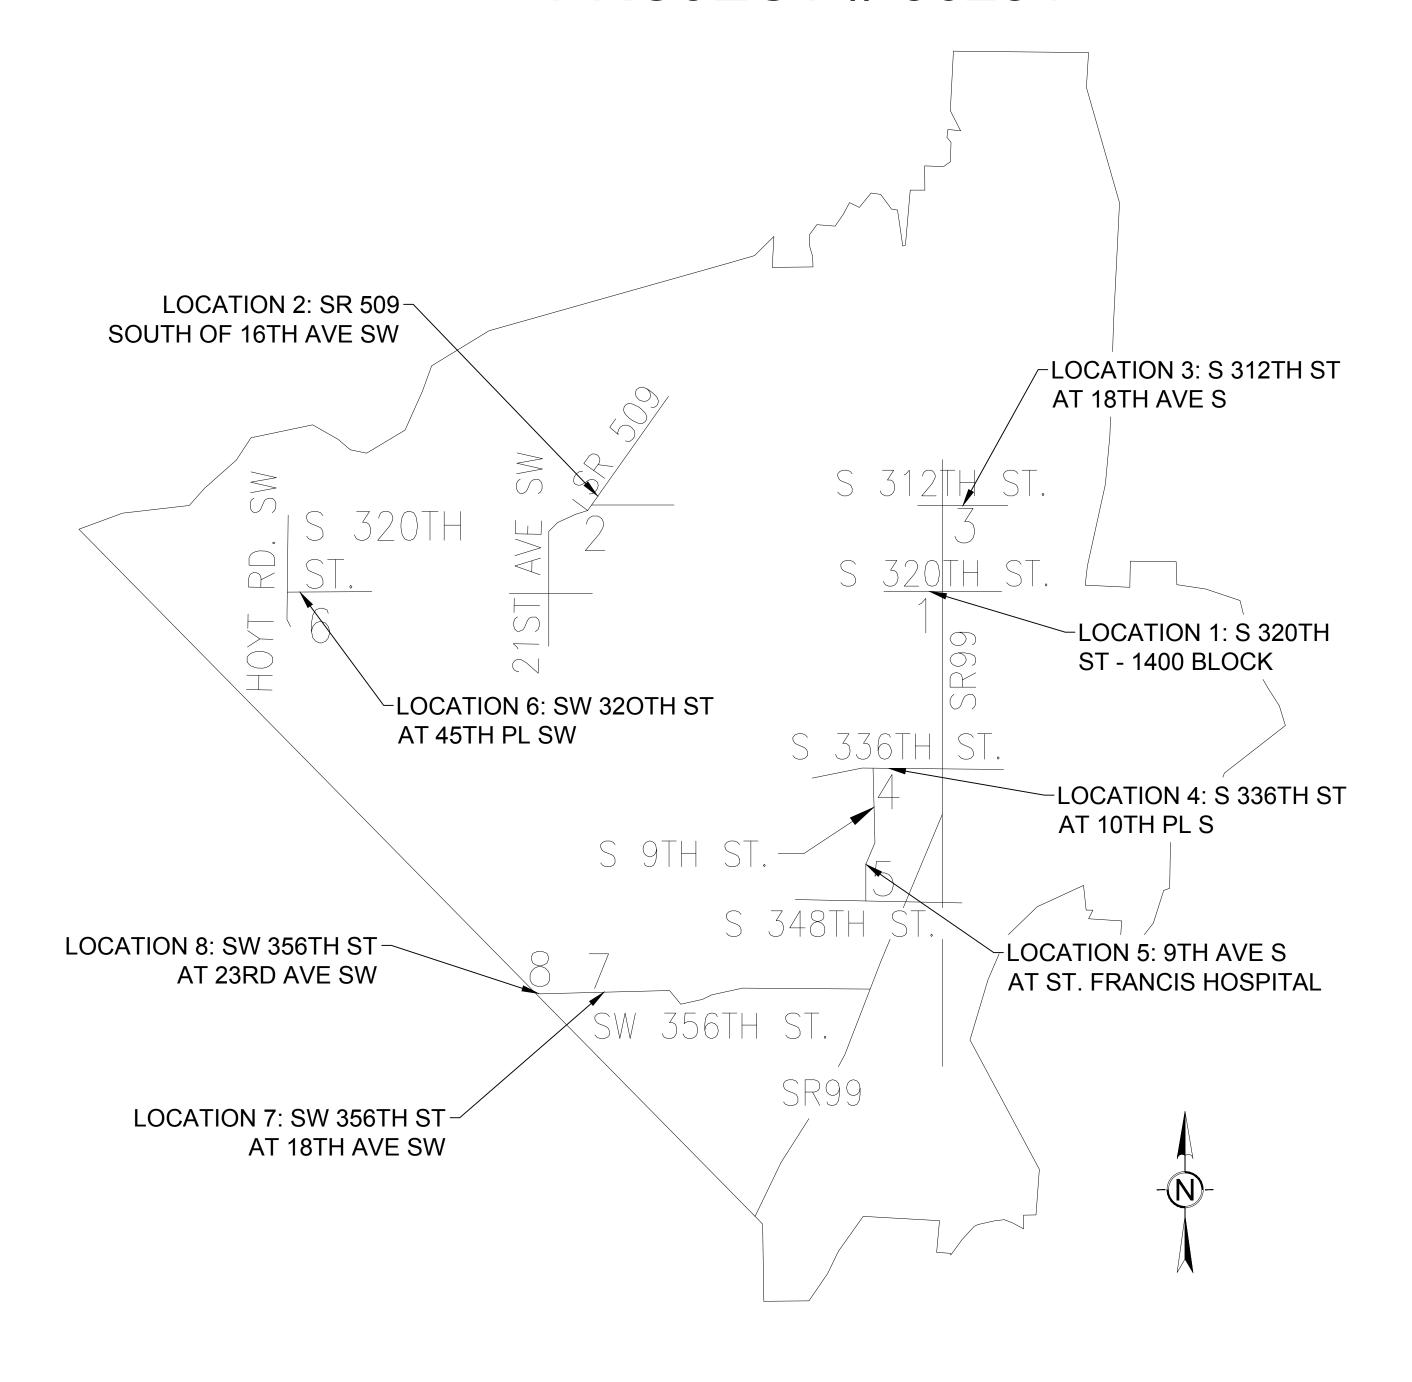





FED. AID # HSIP-00S(605) Call before you dig. RFB #23-008

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T 253.627.4367 F 253.627.4395

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DRAFTED: RJB **DESIGNED: MB/SMP** REVIEWED: JBD APPROVED:

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CITYWIDE PEDESTRIAN SAFETY

COVER SHEET

ITY PROJECT 36234 C-001

LEGENDS:

EXISTING FEATURES

(NOTE: NOT ALL SYMBOLS MAY APPEAR ON THE MAP)

SURVEY MONUMENT (AS NOTED)
SECTION CORNER (AS NOTED)
SET REBAR/CAP (LS#45789 OR #41282)

YARD LIGHT POWER METER (PM) -○- POWER POLE (PP) oxtimes Junction box (as noted) POWER OUTLET

TELEPHONE MANHOLE (TM)

□ TELEPHONE RISER (TR) ☐ CATCH BASIN (CB) STORM MANHOLE (SDMH) o STORM CLEANOUT (SDCO) S SANITARY SEWER MANHOLE (SSMH)

 SANITARY CLEANOUT (SSCO) GAS VALVE (GV) WATER VALVE (WV) FIRE HYDRANT(FH) oxplus WATER METER (WM) → BLOW-OFF / AIRVAC

⇒ DIRECTIONAL ARROW - X - X - X - CHAIN LINK FENCE -/-/- WOOD FENCE — w — w − WATER LINE

— G — G — GAS LINE ——T(XX)—— TELEPHONE LINE (OH) OR (UG) — P(XX)— POWER LINE (OH) OR (UG) ---- SS ---- SEWER LINE

COOC ROCKERY KEYSTONE WALL 0 DECIDUOUS TREE CONIFEROUS TREE TREE DRIPLINE

CONCRETE ASPHALT _____ BUILDING LINE

PROPOSED FEATURES

---- CLEARING LIMITS REMOVE ASPHALT PAVEMENT ---- SAWCUT - X- X- X- X- X- X- REMOVE EXISTING CURB

REMOVE CEMENT CONCRETE SIDEWALK REMOVE EXISTING TREE —— — — RIGHT-OF-WAY LINE

——— — ROAD CENTERLINE CURB RAMP PAY LIMITS

HMA PAVEMENT HMA PAVEMENT BACKFILL

CEMENT CONCRETE SIDEWALK DETECTABLE WARNING SURFACE (YELLOW)

> DETECTABLE WARNING SURFACE (BLACK) SEEDED LAWN BARK MULCH

. / . ' , ' / . ' , ' EXTRUDED CURB CURB & GUTTER

SIGN TYPE 2Y RPM

28" TUBULAR MARKER SIGNAL POLE (REFER TO RRFB PLANS) RRFB POLE (REFER TO RRFB PLANS)

JUNCTION BOX (REFER TO RRFB PLANS)

R RADIUS

ABBREVIATIONS

AC ACRE

APPROX APWA	APPROXIMATELY AMERICAN PUBLIC WORKS ASSOCIATION	GRVL GV	GRAVEL GAS VALVE	RCW ROW RT	REVISED CODE OF WASHINGTON RIGHT-OF-WAY RIGHT
ARCH ASPH ASTM AVE	ARCHITECTURAL ASPHALT AMERICAN SOCIETY FOR TESTING AND MATERIALS AVENUE	H HDPE HMA HORIZ	HEIGHT HIGH DENSITY POLYETHYLENE HOT MIX ASPHALT HORIZONTAL		SOUTH STORM CEPTOR SCHEDULE STORM DRAIN
BLDG BMP BG	BUILDING BEST MANAGEMENT PRACTICE BOTTOM OF GRADE	ID IE IN	INSIDE DIAMETER INVERT ELEVATION INCH	SDMH SDR SF SPECS	STORM DRAIN MANHOLE STANDARD DIMENSION RATIO SQUARE FEET
BTM BW	BOTTOM OF PIPE BOTTOM OF WALL	L LAT LF	LENGTH LATITUDE LINEAR FEET	SQ YD SS SSCO	SQUARE YARD SANITARY SEWER SANITARY SEWER CLEANOUT
Ç CB CF	CENTERLINE CATCH BASIN CUBIC FEET	LON LT	LONGITUDE LEFT	ST STA STD	STREET STATION STANDARD
CI CL CMP	CAST IRON CLASS CORRUGATED METAL PIPE	MAX MH MIN	MAXIMUM MANHOLE MINIMUM	SWPPP	PREVENTION PLAN
CO COFW CONC CPEP	CLEAN OUT CITY OF FEDERAL WAY CONCRETE CORRUGATED POLYETHYLENE	MISC MJ MON	MISCELLANEOUS MECHANICAL JOINT MONUMENT	T TC TEMP TESC	TELEPHONE TOP OF CURB TEMPORARY TEMPORARY EROSION &
CR CSTC	PIPE CROWN OF PIPE CRUSHED SURFACING TOP COURSE	N NC NO. NTS	NORTH NO CURB NUMBER NOT TO SCALE	TG TP TW TYP	SEDIMENT CONTROL TOP OF GRADE TOP OF PAVEMENT TOP OF WALL TYPICAL
DEPT DI	DEPARTMENT DUCTILE IRON	OC OD OFF	ON CENTER OUTSIDE DIAMTER OFFSET	UG UIC	UNDER GROUND UNDER GROUND INJECTION CONTROL
E EA EC	EAST EACH EXTRUDED CURB	PC	POINT OF CURVATURE	Ü.Ö.N. UP	UNLESS OTHERWISE NOTED UTILITY POLE
EG ELEV	EXISTING GRADE ELEVATION	PCC PI PL	POINT OF COMPOUND CURVE POINT OF INTERSECTION PROPERTY LINE	V	VERTICAL
EP ESC EXIST	EDGE OF PAVEMENT EROSION & SEDIMENT CONTROL EXISTING	PP	POWER POLE POINT OF REVERSE CURVE PROPOSED POINT OF TANGENCY	W W/ WAC WSDOT	WEST WITH WASHINGTON ADMINISTRATIVE CODE WASHINGTON STATE DEPARTMENT
FFE FG FH	FINISH FLOOR ELEVATION FINISHED GRADE FIRE HYDRANT	PVC PVMT	POLYVINYL CHLORIDE PAVEMENT	WV	OF TRANSPORTATION WATER VALVE
FĽ	FLANGED			YD	YARD DRAIN



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DRAFTED: RJB

DESIGNED: MB/SMP

REVIEWED: JBD

APPROVED:

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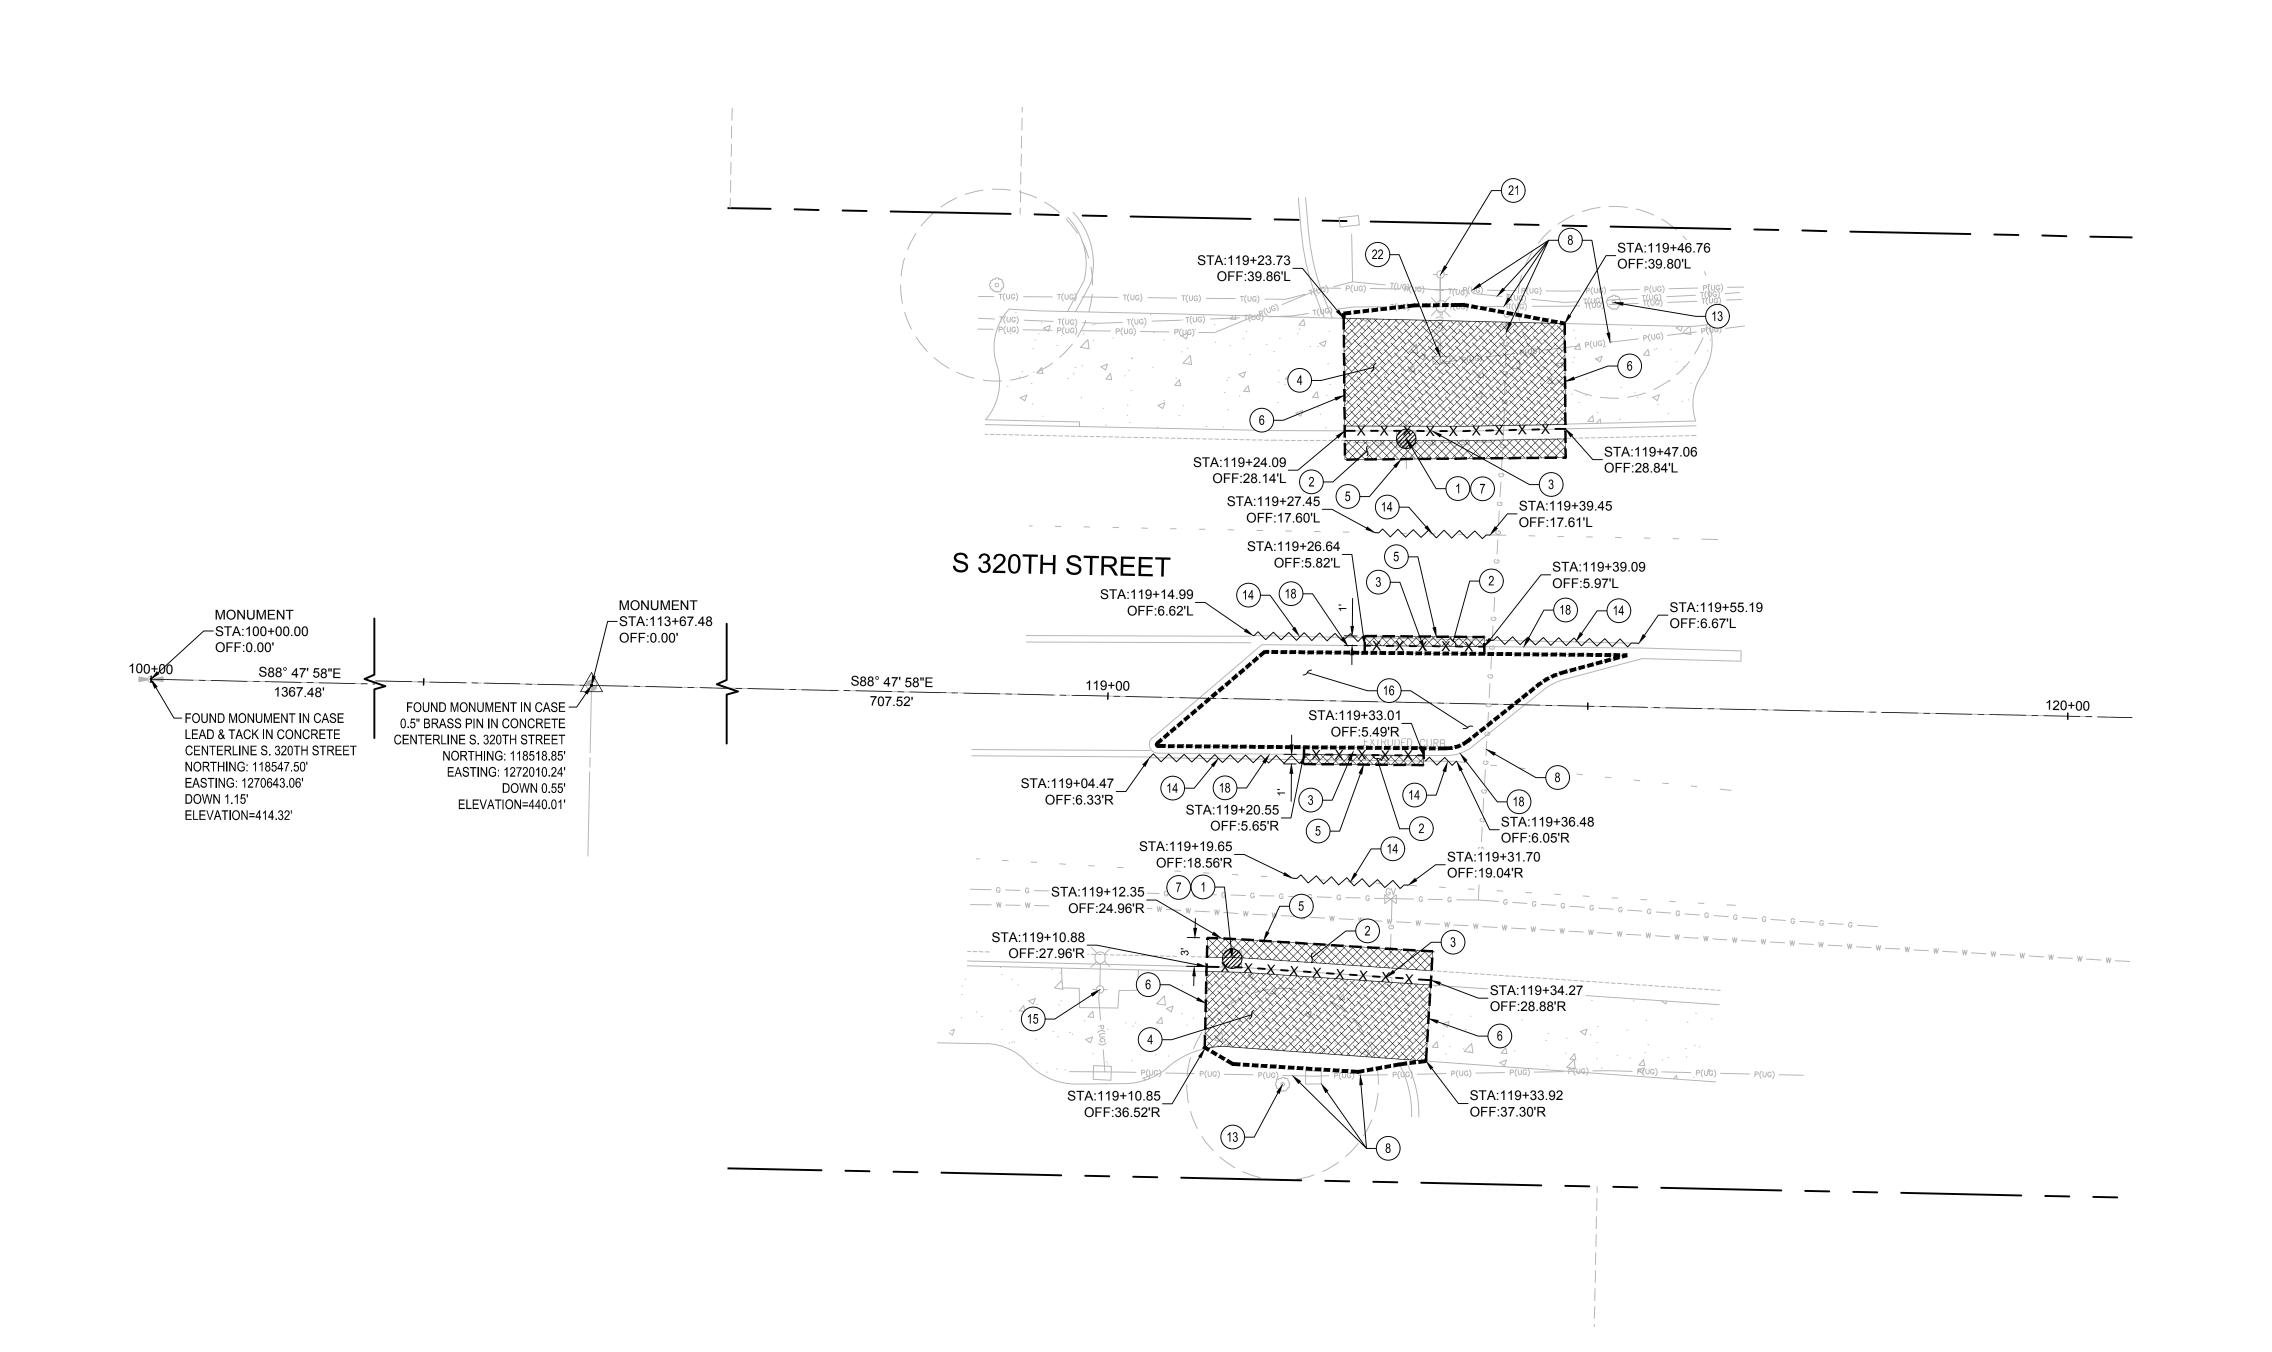
CITYWIDE PEDESTRIAN SAFETY

LEGEND AND ABBREVIATIONS

CITY PROJECT # 36234 SHEET C-002

2 of 37

100% DESIGN



- (1) INSTALL INLET PROTECTION PER WSDOT STD PLAN I-40.20-00.
- REMOVE EXISTING ASPHALT PAVEMENT TO BASE ROCK. IF BASE ROCK IS $^\prime$ UNSUITABLE FOR REGRADING AND COMPACTION REMOVE FULL PAVEMENT SECTION TO SUBGRADE.
- $ig(\,3\,ig)$ REMOVE EXISTING CURB OR CURB AND GUTTER.
- (4) REMOVE EXISTING CEMENT CONCRETE SIDEWALK.
- (5) SAWCUT, LEAVE NEAT UNIFORM EDGE.
- (6) SAWCUT AT NEAREST JOINT, LEAVE NEAT UNIFORM EDGE. STATIONS SHOWN ON PLAN ARE APPROXIMATE.
- $\left(\begin{smallmatrix}7\end{smallmatrix}\right)$ PROTECT EXISTING STRUCTURE AND ASSOCIATED LINES.
- (8) PROTECT EXISTING UTILITY.
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- (11) RELOCATE EXISTING BOULDERS. REFER TO PAVING AND GRADING PLANS.
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- (21) REMOVE EXISTING LIGHT POLE. REFER TO RRFB PLANS.
- REMOVE EXISTING JUNCTION BOX. REFER TO RRFB PLANS FOR NEW JUNCTION BOX LOCATION. LOCATION.
- (23) REPLACE EXISTING JUNCTION BOX IN PLACE. REFER TO RRFB PLANS.
- (24) PROTECT EXISTING FENCE.



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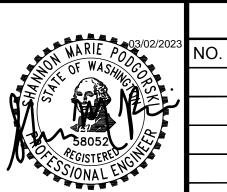
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DRAFTED: RJB



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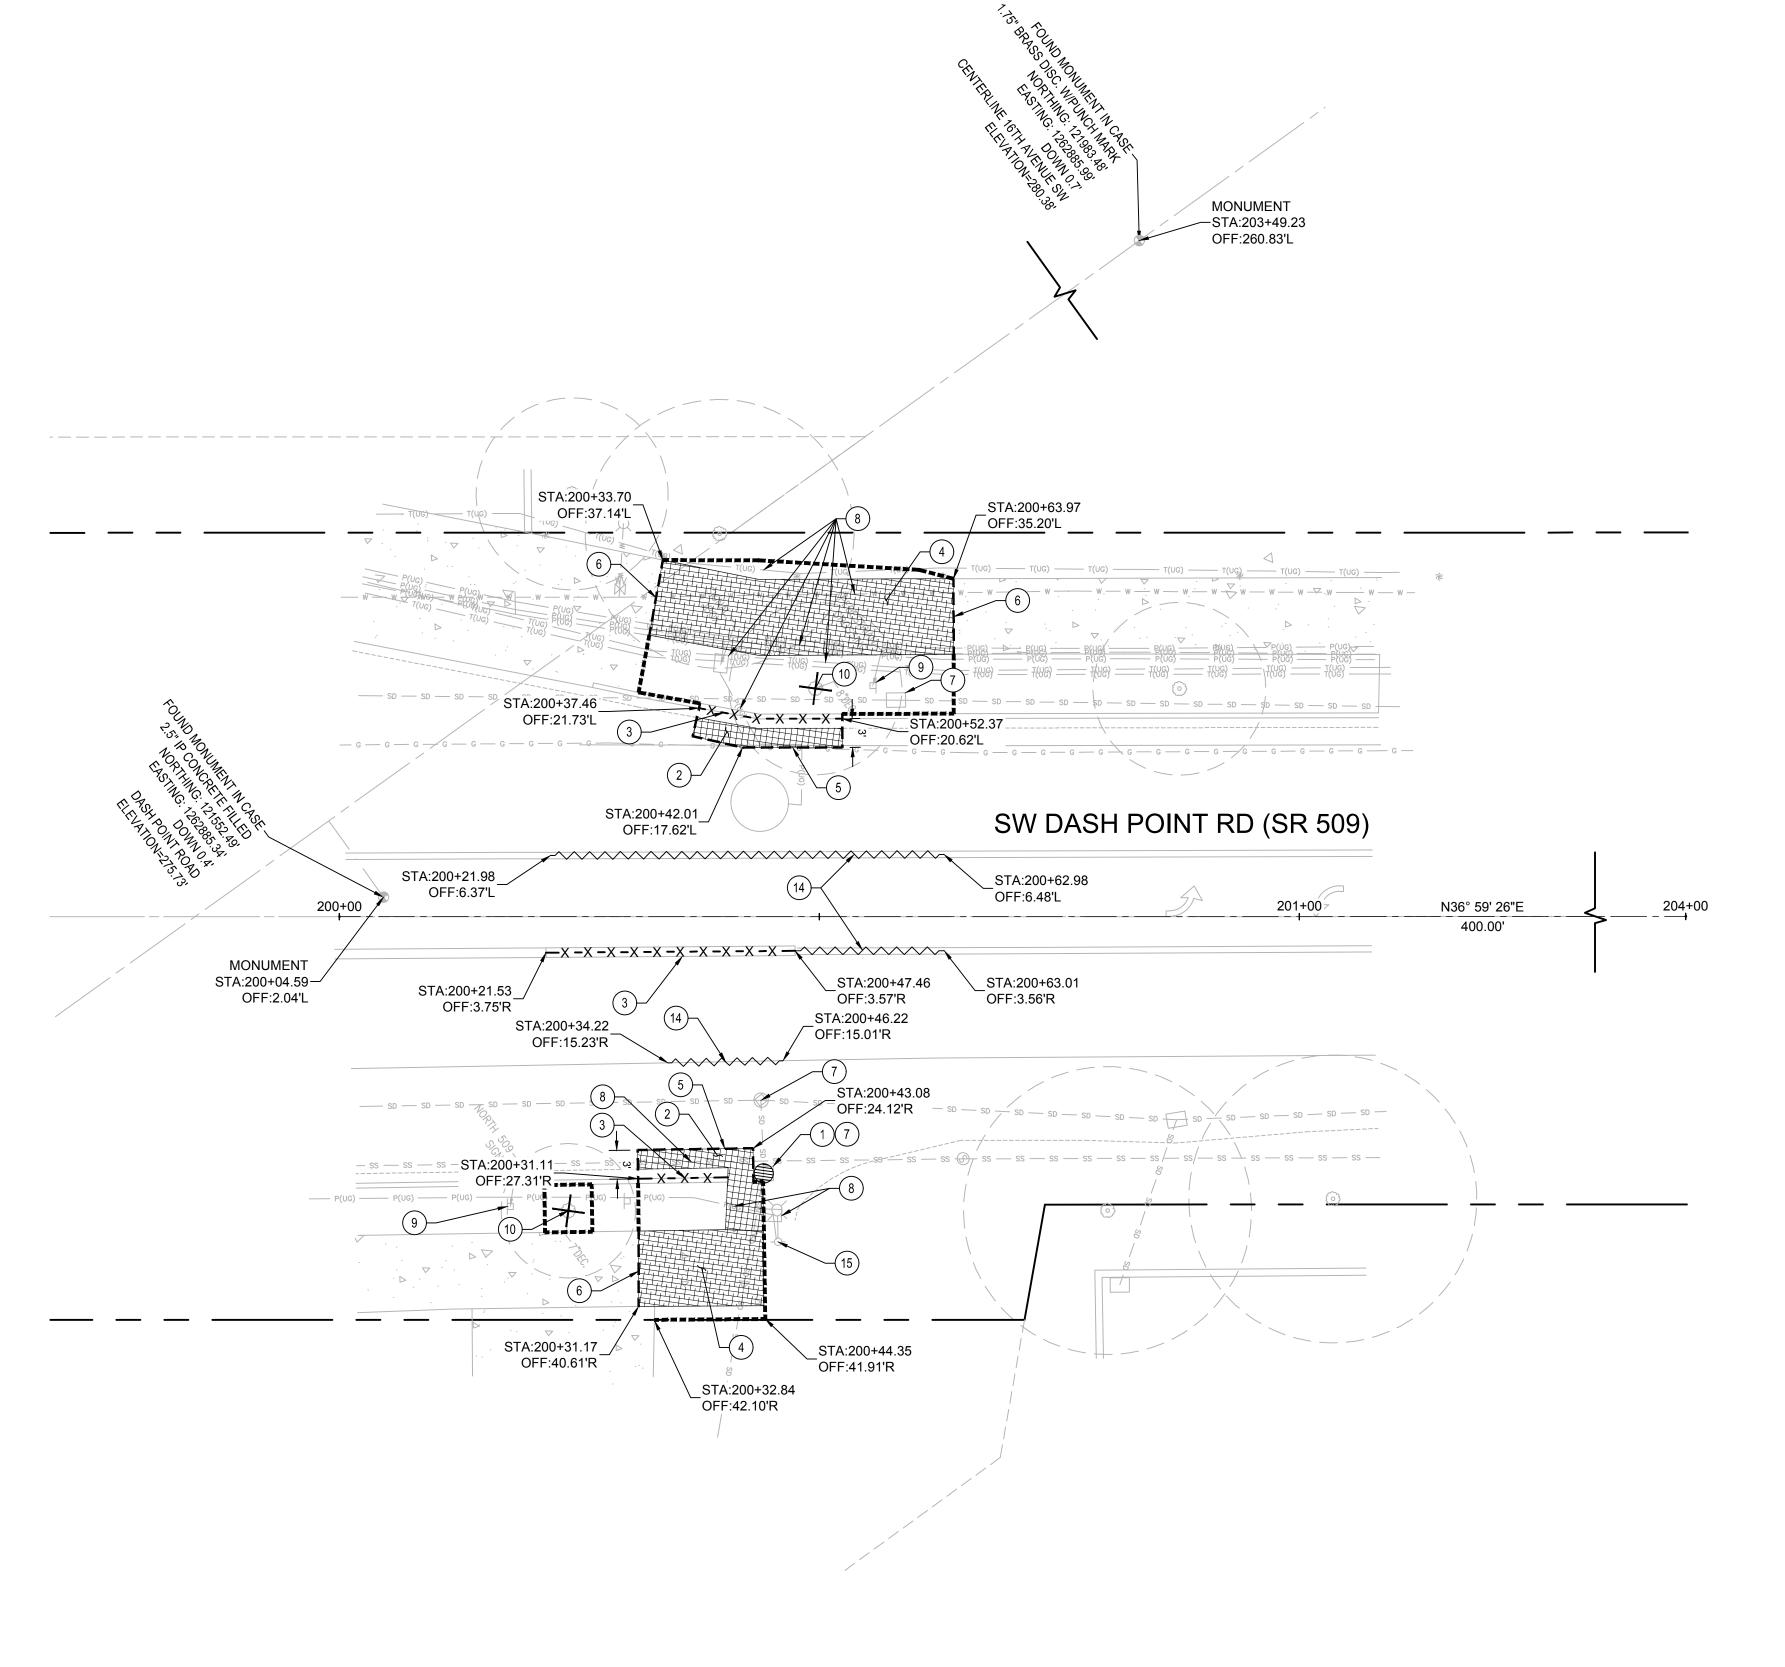
CITYWIDE PEDESTRIAN SAFETY

SITE PREPARATION AND SURVEY CONTROL PLAN LOCATION 1: S 320TH ST - 1400 BLOCK

100% DESIGN

36234

C-101



(1) INSTALL INLET PROTECTION PER WSDOT STD PLAN I-40.20-00.

REMOVE EXISTING ASPHALT PAVEMENT TO BASE ROCK. IF BASE ROCK IS UNSUITABLE FOR REGRADING AND COMPACTION REMOVE FULL PAVEMENT SECTION TO SUBGRADE.

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(5) SAWCUT, LEAVE NEAT UNIFORM EDGE.

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DESIGNED: MB/SMP

REVIEWED: JBD

APPROVED:

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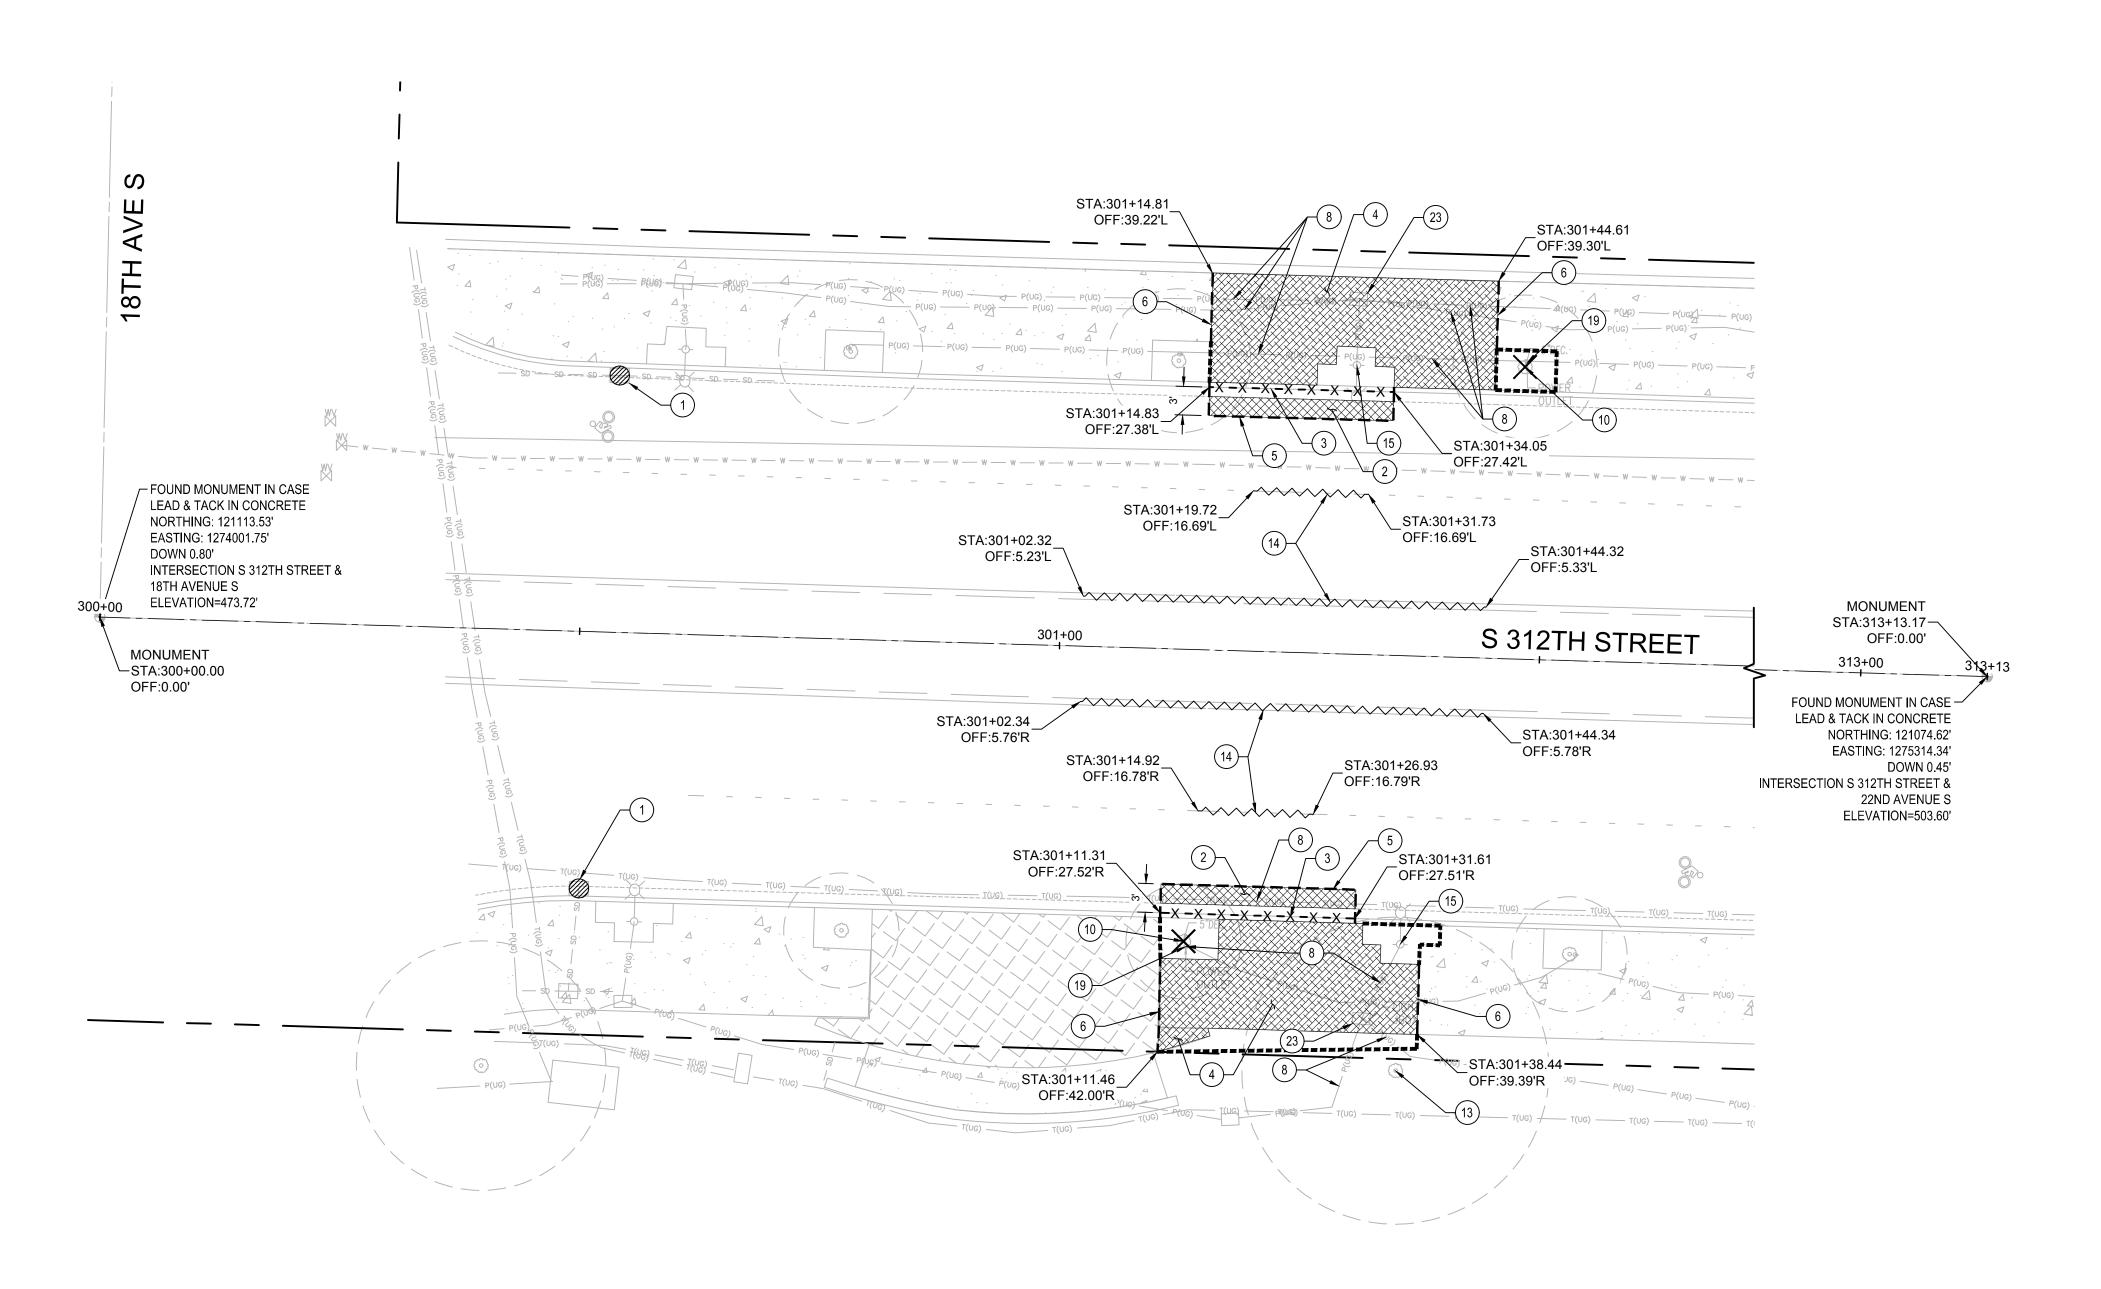
CITYWIDE PEDESTRIAN SAFETY

SITE PREPARATION AND SURVEY CONTROL PLAN LOCATION 2: SR 509 SOUTH OF 16TH AVE SW


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C-102



- (1) INSTALL INLET PROTECTION PER WSDOT STD PLAN I-40.20-00.
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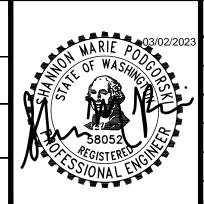
DRAFTED: RJB

DESIGNED: MB/SMP

REVIEWED: JBD

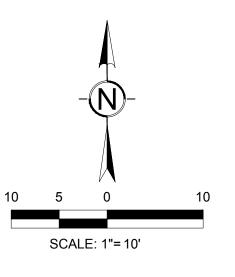APPROVED:

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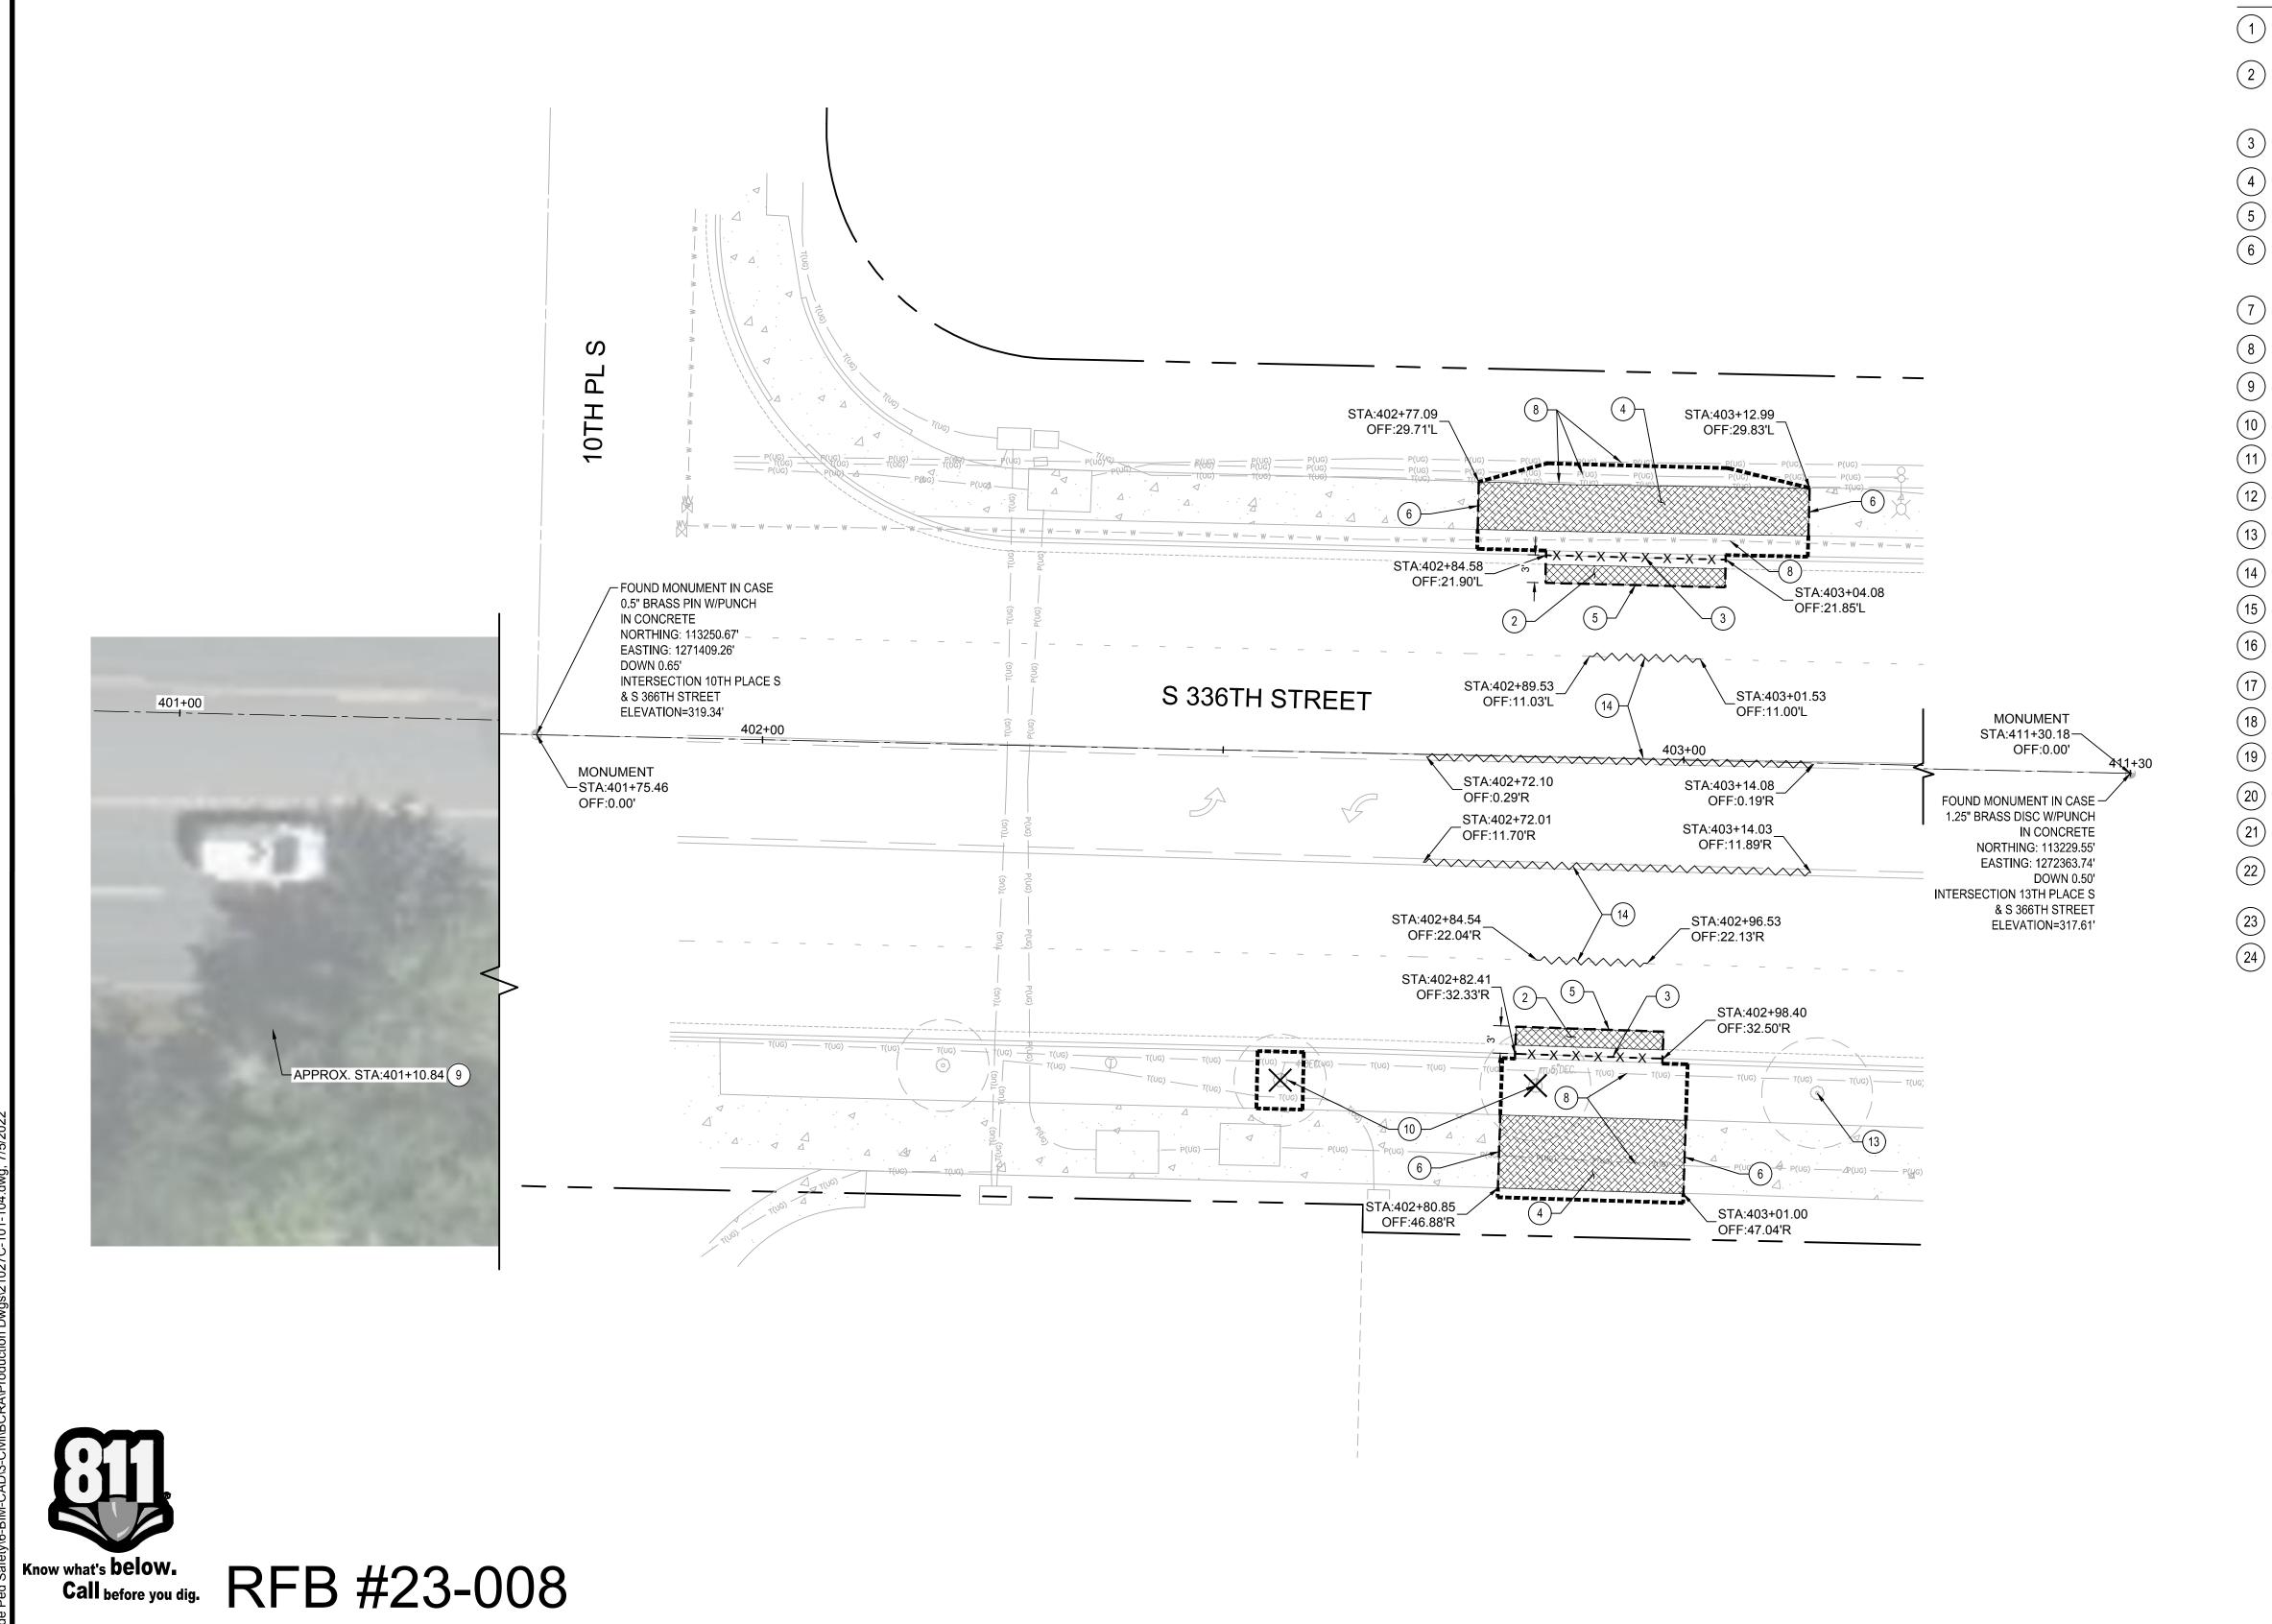
CITYWIDE PEDESTRIAN SAFETY

SITE PREPARATION AND SURVEY CONTROL PLAN LOCATION 3: S 312TH ST AT 18TH AVE S

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36234

C-103



- (1) INSTALL INLET PROTECTION PER WSDOT STD PLAN I-40.20-00.
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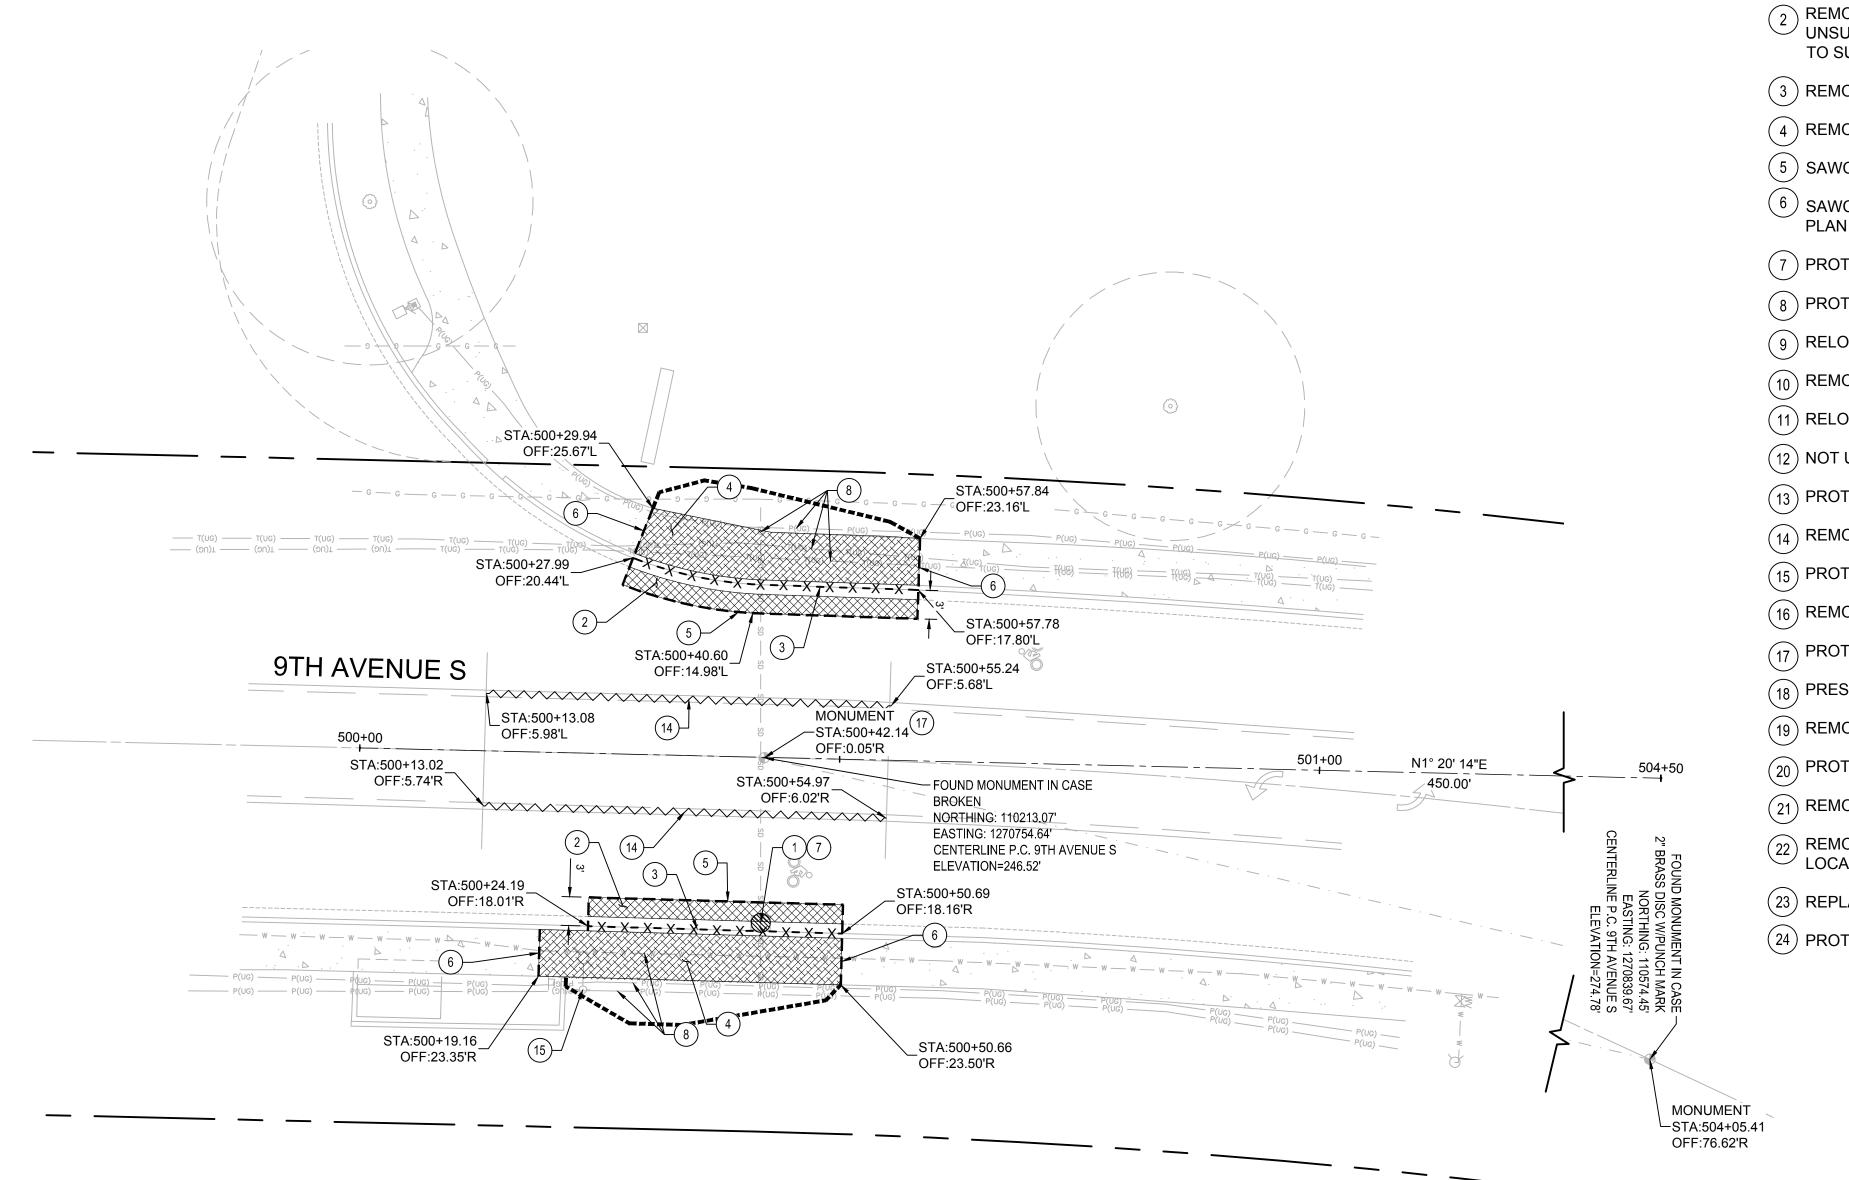
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CITYWIDE PEDESTRIAN SAFETY

SITE PREPARATION AND SURVEY CONTROL PLAN LOCATION 4: S 336TH ST AT 10TH PL S

36234

C-104





 $\begin{pmatrix} 1 \end{pmatrix}$ INSTALL INLET PROTECTION PER WSDOT STD PLAN I-40.20-00.

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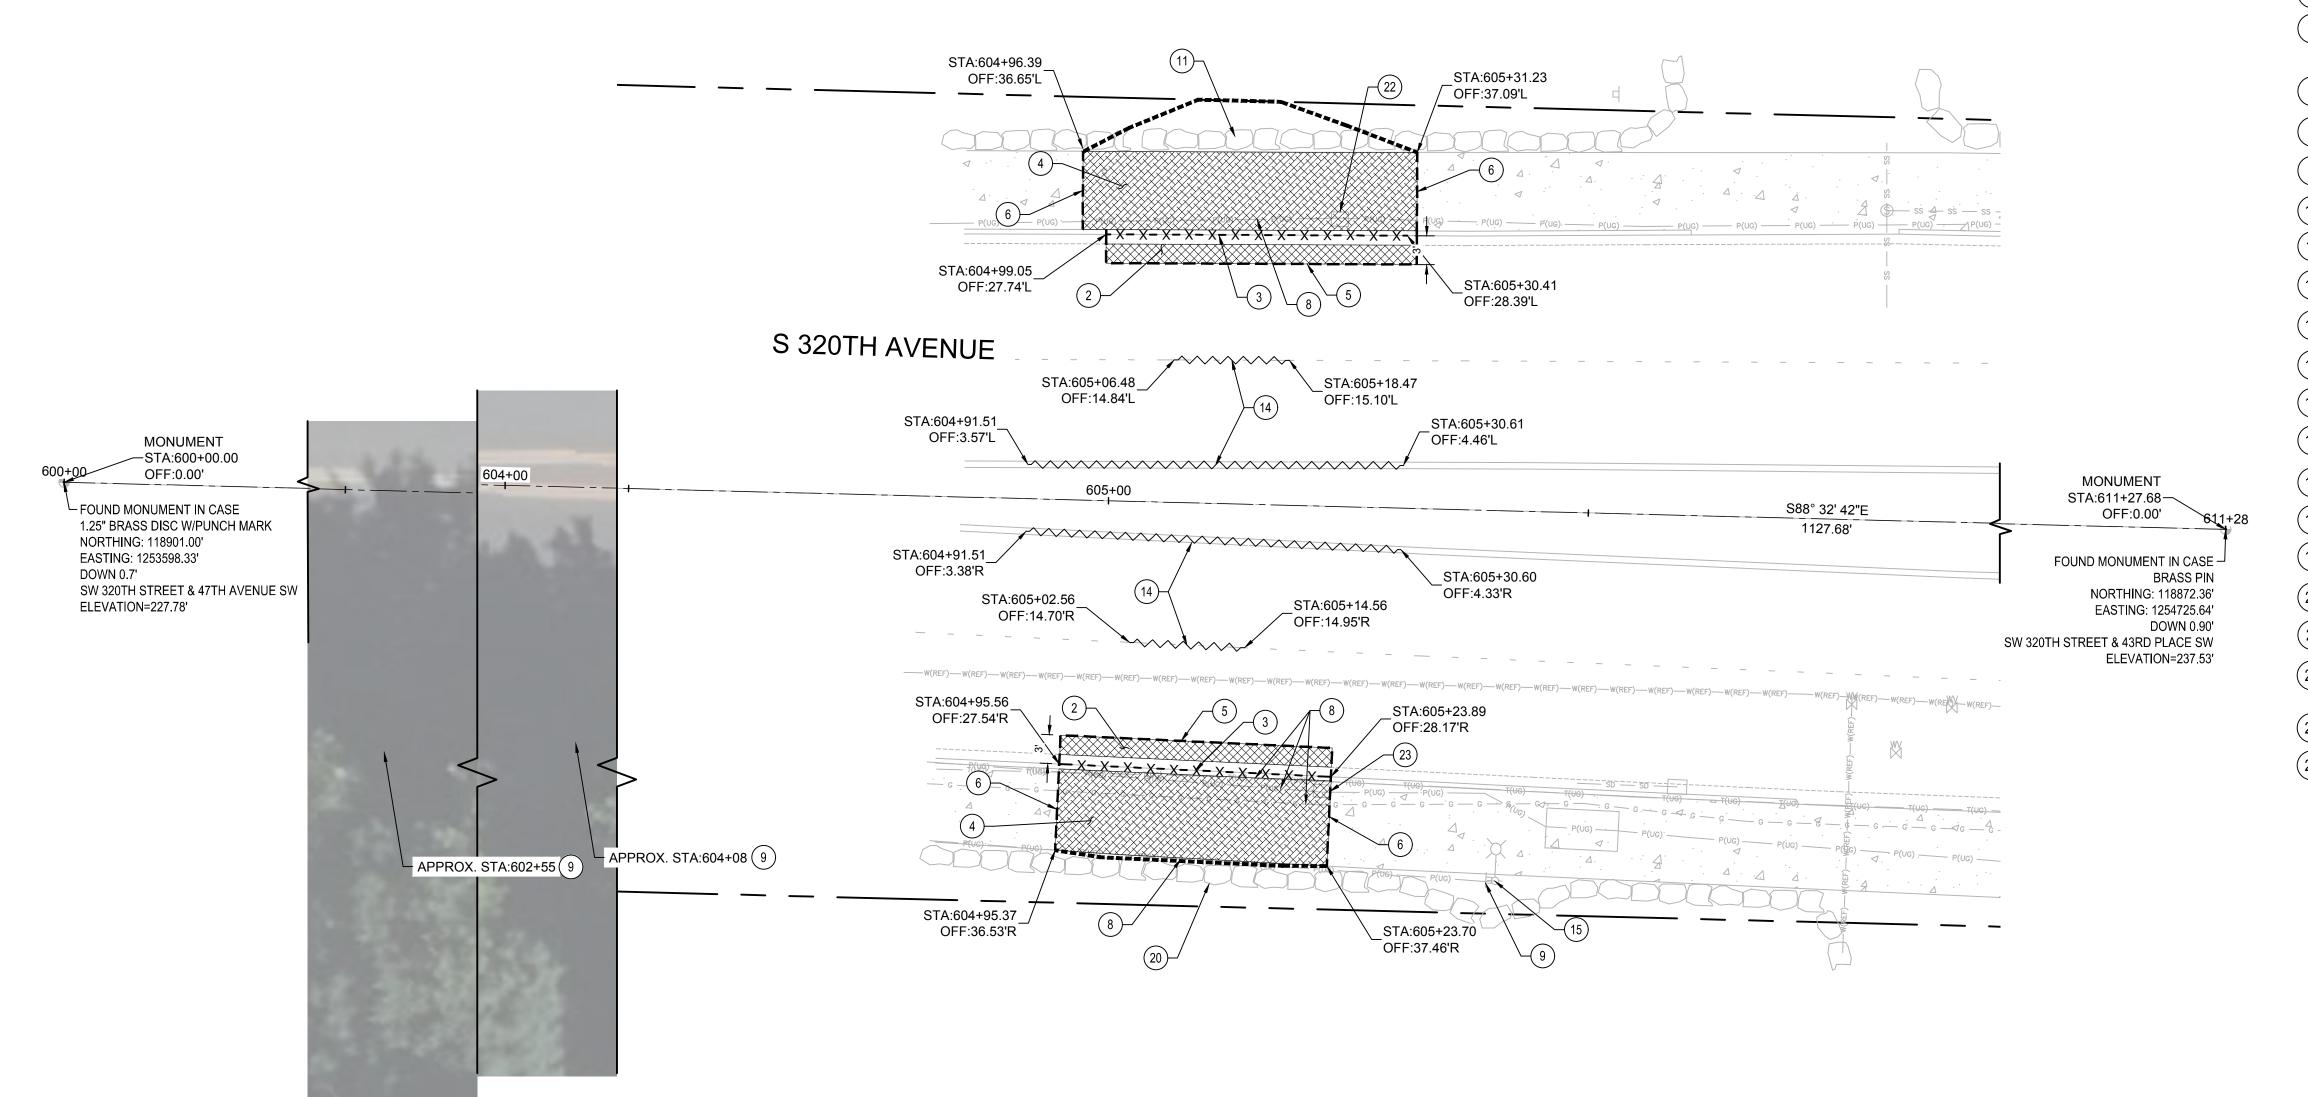
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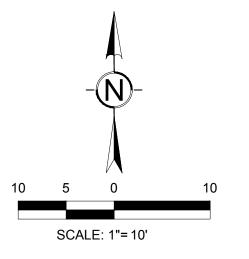
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SITE PREPARATION AND SURVEY CONTROL PLAN LOCATION 5: 9TH AVE S AT ST. FRANCIS HOSPITAL 36234

C-105



- (1) INSTALL INLET PROTECTION PER WSDOT STD PLAN I-40.20-00.
- REMOVE EXISTING ASPHALT PAVEMENT TO BASE ROCK. IF BASE ROCK IS $^\prime$ UNSUITABLE FOR REGRADING AND COMPACTION REMOVE FULL PAVEMENT SECTION. TO SUBGRADE.
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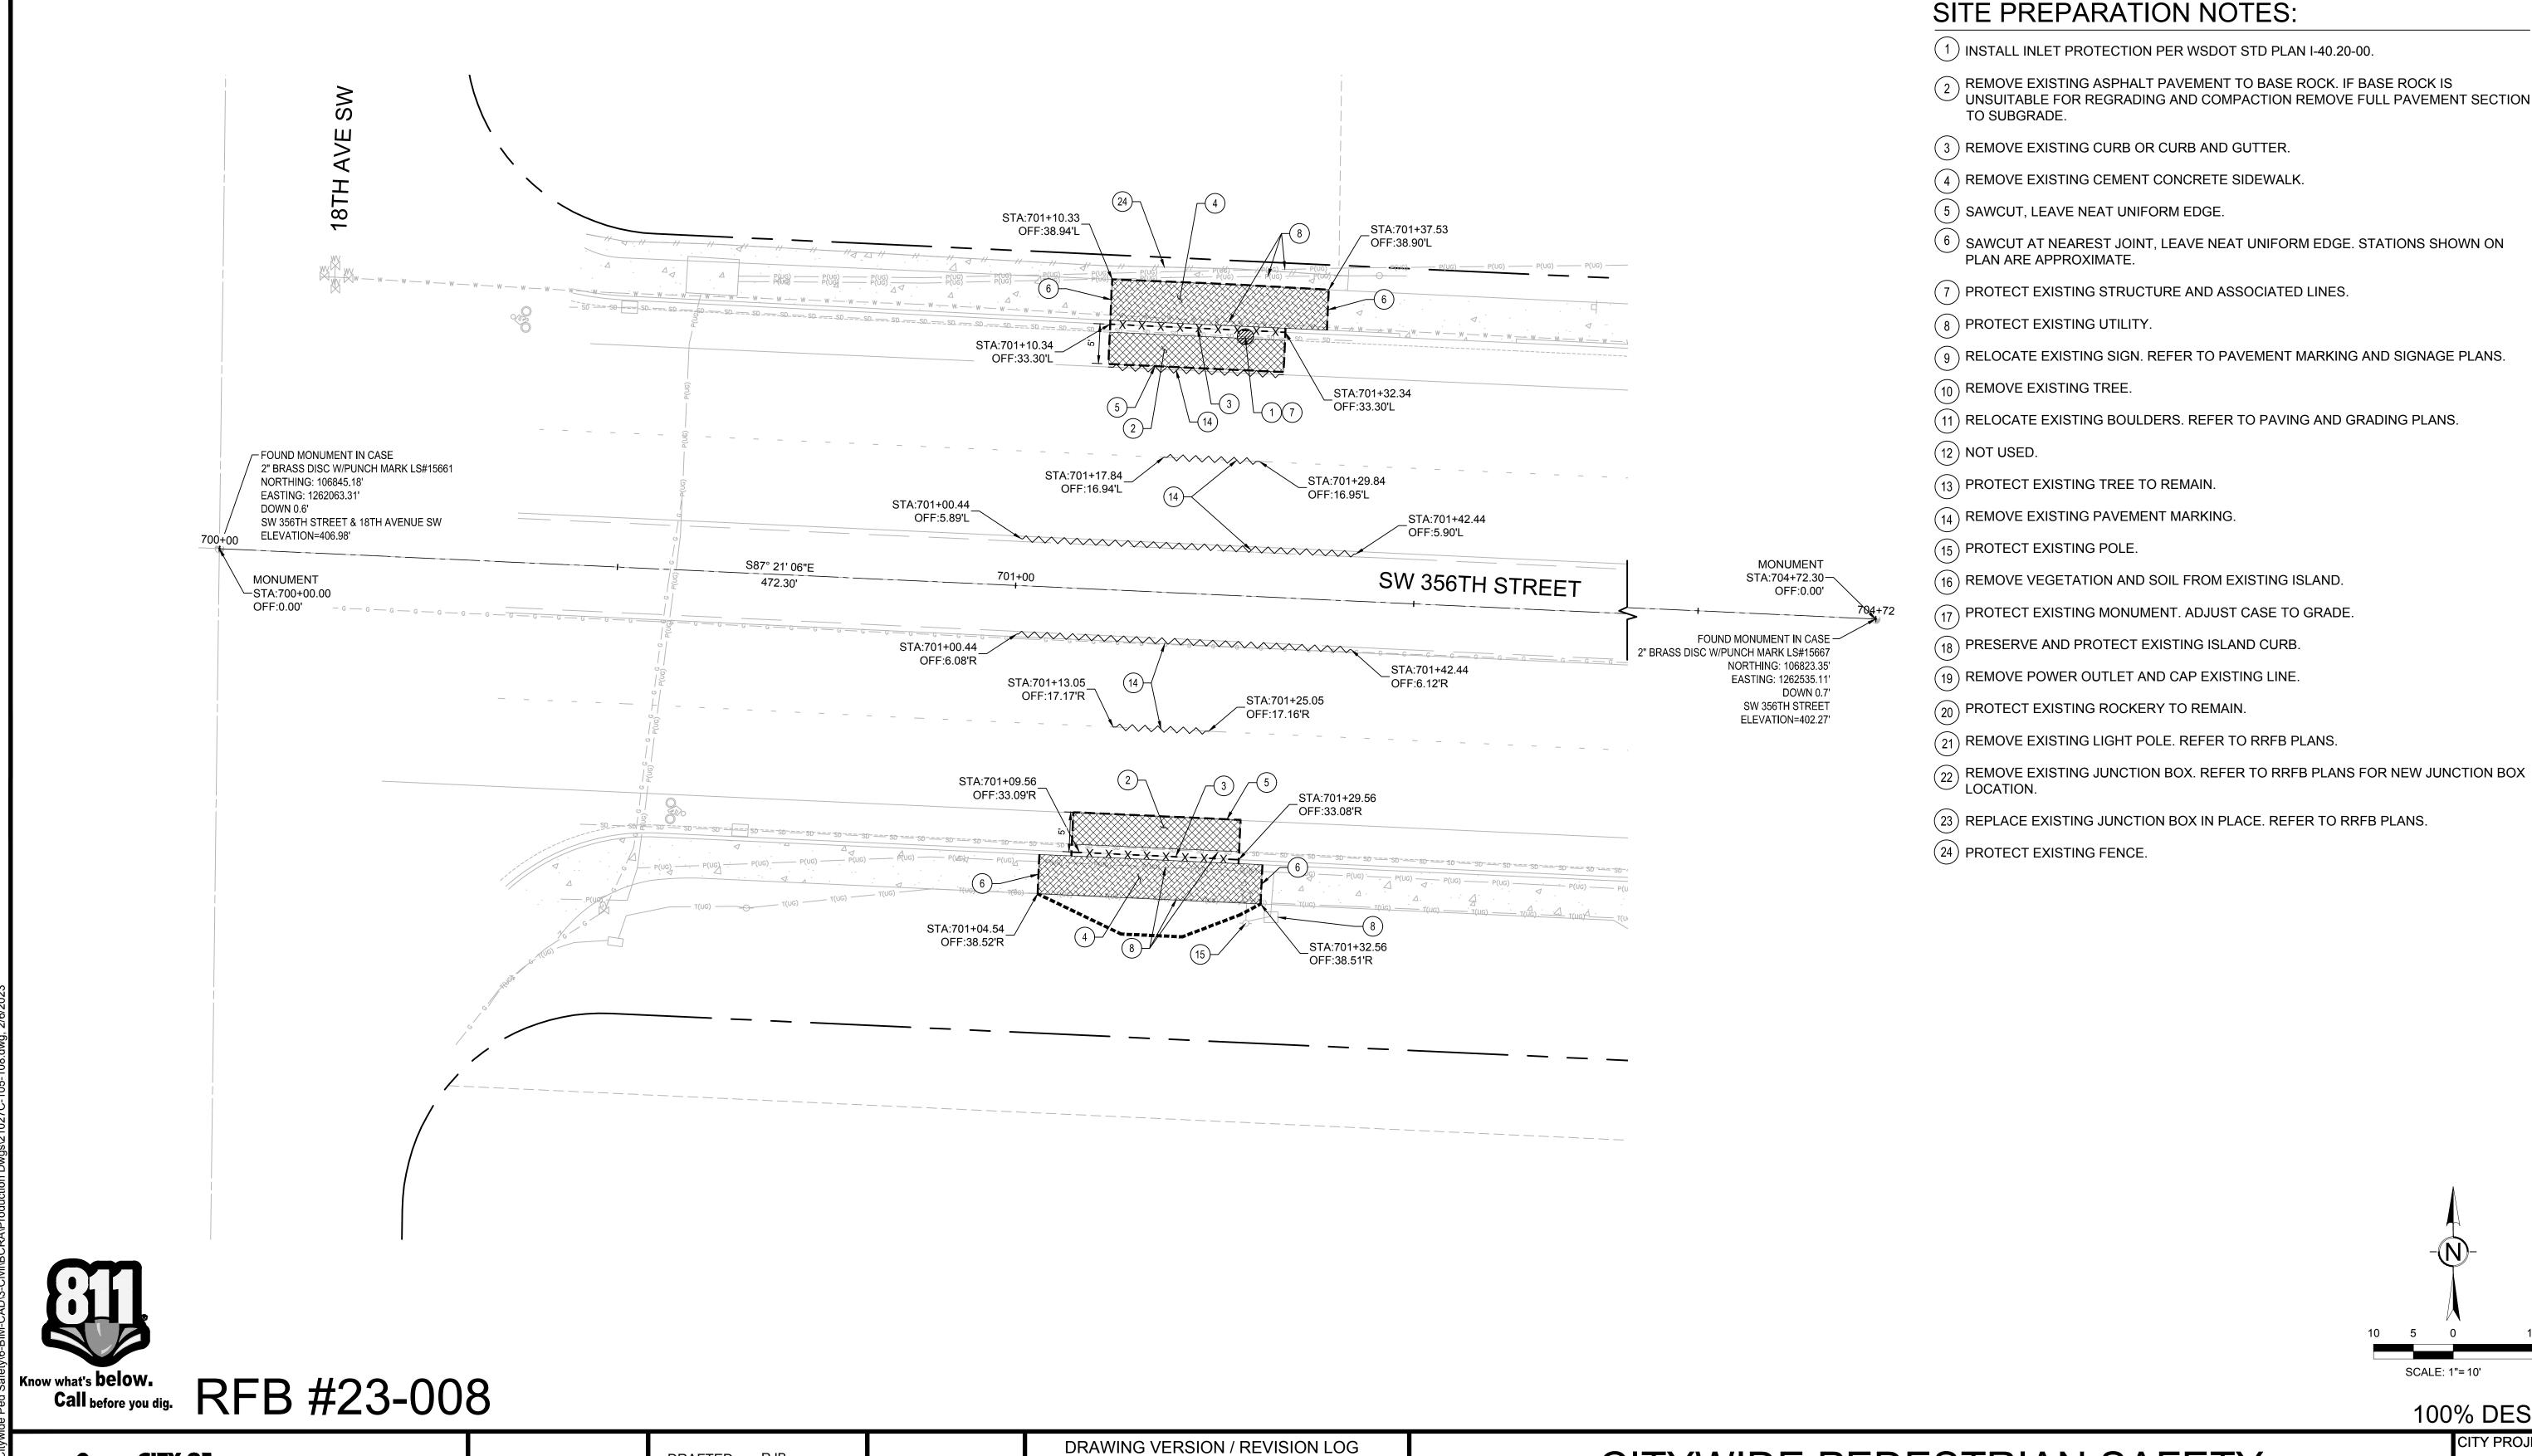
CITYWIDE PEDESTRIAN SAFETY

SITE PREPARATION AND SURVEY CONTROL PLAN LOCATION 6: SW 320TH ST AT 45TH PL SW

100% DESIGN

C-106

36234



Federal Way
Centered on Opportunity 33325 8TH AVE S FEDERAL WAY, WA 98003 PHONE: (253) 835-2700

WWW.CITYOFFEDERALWAY.COM

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DRAFTED: RJB

DESIGNED: MB/SMP

REVIEWED: JBD

APPROVED:

T 253.627.4367 F 253.627.4395 WWW.BCRADESIGN.COM

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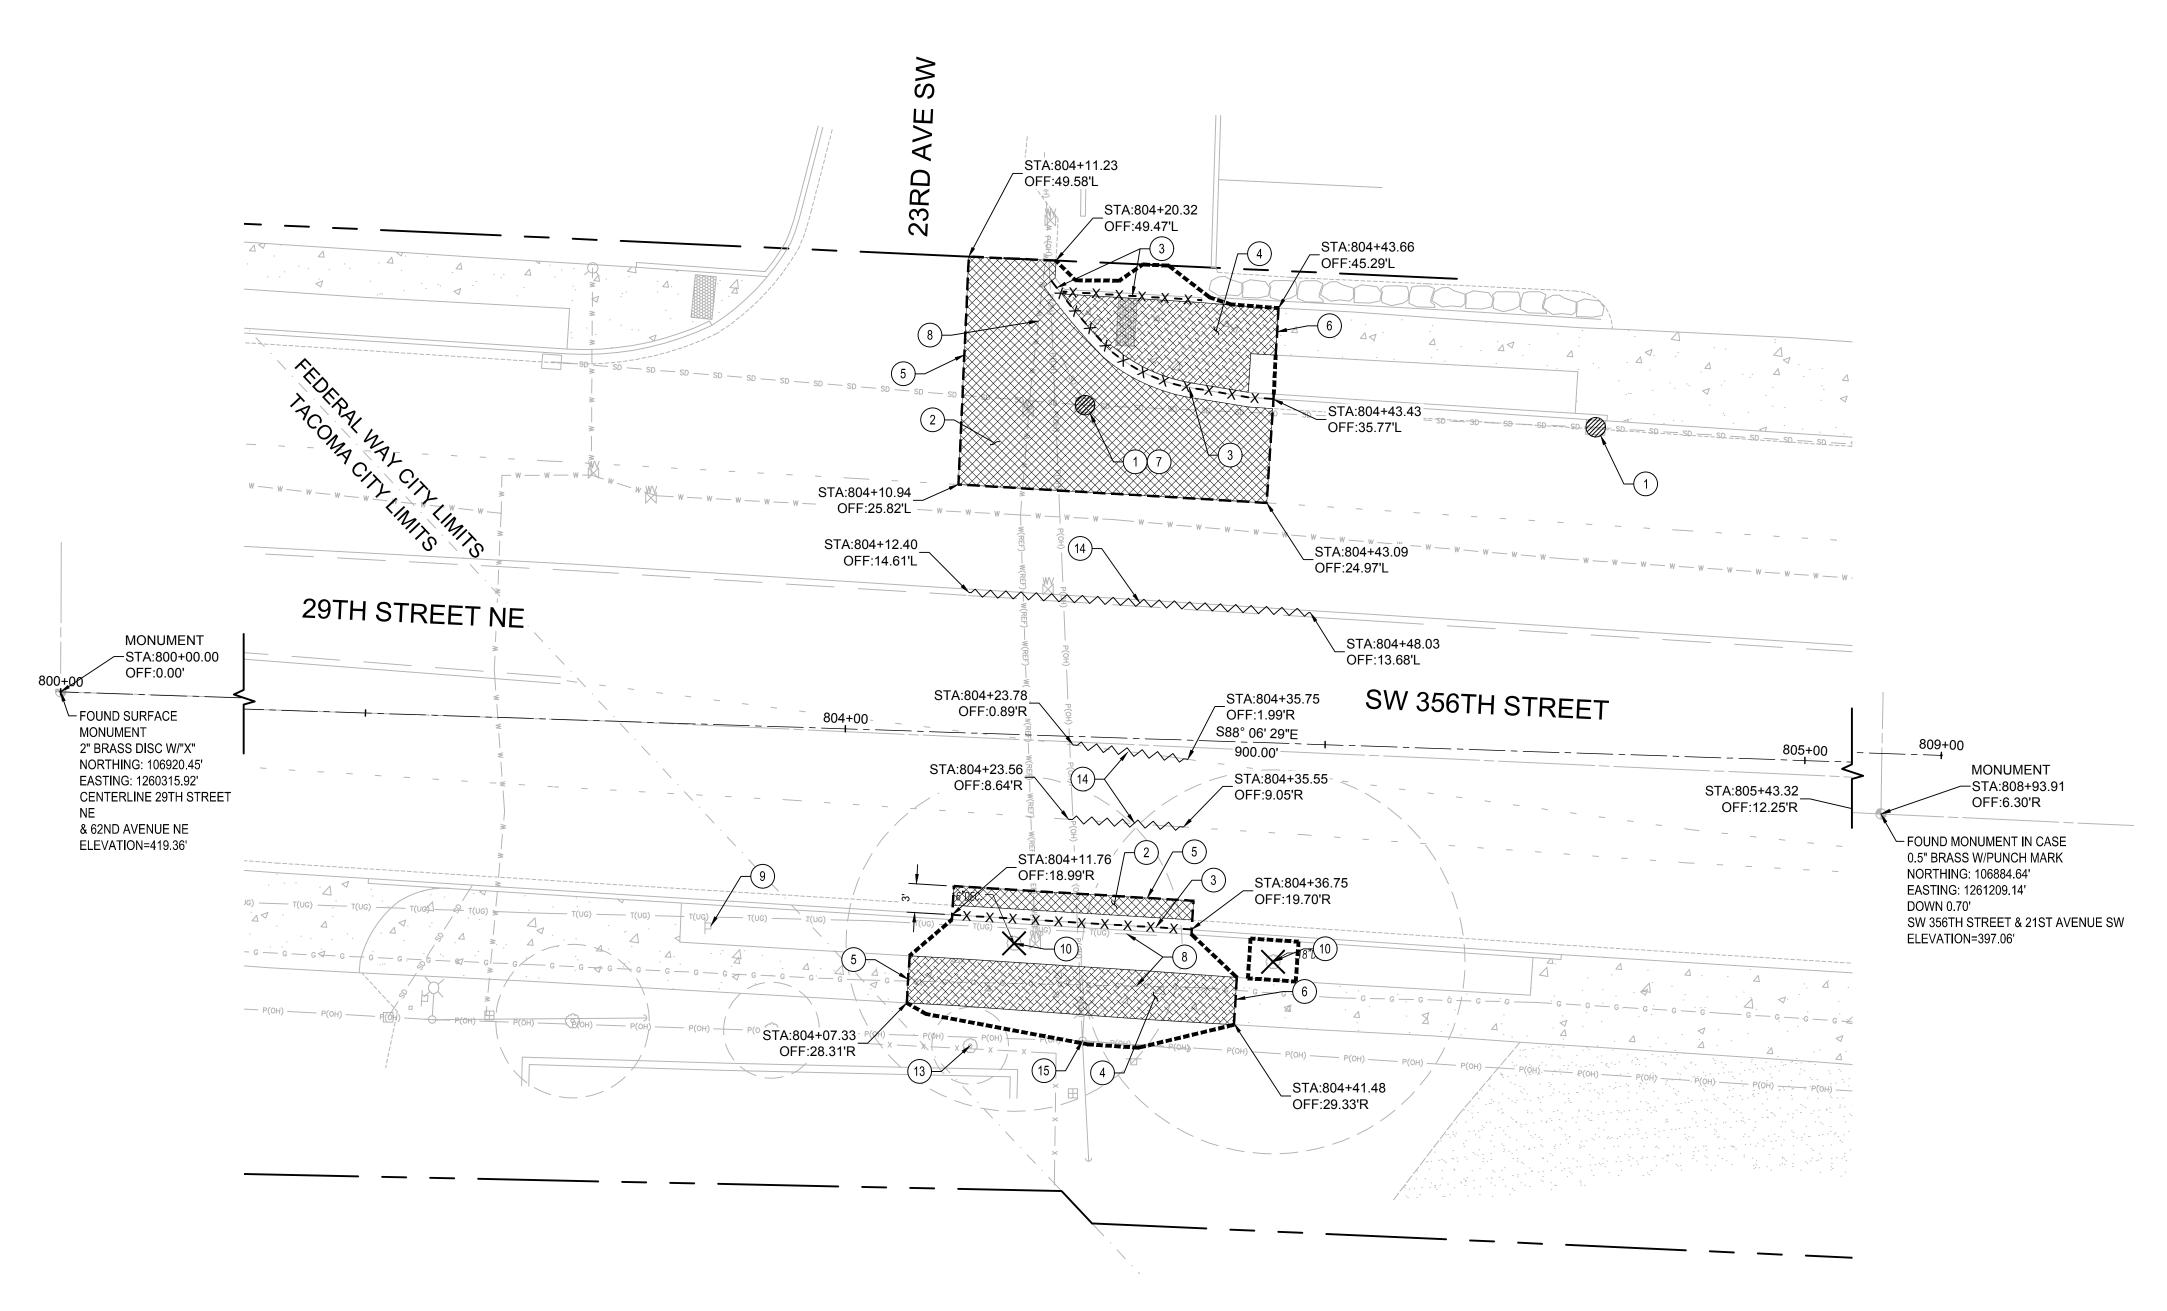
CITYWIDE PEDESTRIAN SAFETY

SITE PREPARATION AND SURVEY CONTROL PLAN LOCATION 7: SW 356TH ST AT 18TH AVE SW

100% DESIGN

C-107

36234



- $\begin{pmatrix} 1 \end{pmatrix}$ INSTALL INLET PROTECTION PER WSDOT STD PLAN I-40.20-00.
- REMOVE EXISTING ASPHALT PAVEMENT TO BASE ROCK. IF BASE ROCK IS $^\prime$ UNSUITABLE FOR REGRADING AND COMPACTION REMOVE FULL PAVEMENT SECTION. TO SUBGRADE.
- (3) REMOVE EXISTING CURB OR CURB AND GUTTER.
- (4) REMOVE EXISTING CEMENT CONCRETE SIDEWALK.
- (5) SAWCUT, LEAVE NEAT UNIFORM EDGE.
- (6) SAWCUT AT NEAREST JOINT, LEAVE NEAT UNIFORM EDGE. STATIONS SHOWN ON PLAN ARE APPROXIMATE.
- (7) PROTECT EXISTING STRUCTURE AND ASSOCIATED LINES.
- 8 PROTECT EXISTING UTILITY.
- ig(eta ig) RELOCATE EXISTING SIGN. REFER TO PAVEMENT MARKING AND SIGNAGE PLANS.
- (10) REMOVE EXISTING TREE.
- (11) RELOCATE EXISTING BOULDERS. REFER TO PAVING AND GRADING PLANS.
- (12) NOT USED.
- (13) PROTECT EXISTING TREE TO REMAIN.
- (14) REMOVE EXISTING PAVEMENT MARKING.
- (15) PROTECT EXISTING POLE.
- (16) REMOVE VEGETATION AND SOIL FROM EXISTING ISLAND.
- 17) PROTECT EXISTING MONUMENT. ADJUST CASE TO GRADE
- (18) PRESERVE AND PROTECT EXISTING ISLAND CURB
- (19) REMOVE POWER OUTLET AND CAP EXISTING LINE
- 20) PROTECT EXISTING ROCKERY TO REMAIN.
- (21) REMOVE EXISTING LIGHT POLE. REFER TO RRFB PLANS.
- REMOVE EXISTING JUNCTION BOX. REFER TO RRFB PLANS FOR NEW JUNCTION BOX
- (23) REPLACE EXISTING JUNCTION BOX IN PLACE. REFER TO RRFB PLANS.
- (24) PROTECT EXISTING FENCE.



Know what's below.
Call before you dig. RFB #23-008

Federal Way
Centered on Opportunity

33325 8TH AVE S FEDERAL WAY, WA 98003 2106 PACIFIC AVENUE, SUITE 300, TACOMA, WA 98402 PHONE: (253) 835-2700 T 253.627.4367 F 253.627.4395 WWW.CITYOFFEDERALWAY.COM WWW.BCRADESIGN.COM

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DESIGNED: MB/SMP REVIEWED: JBD APPROVED:

DRAFTED: RJB

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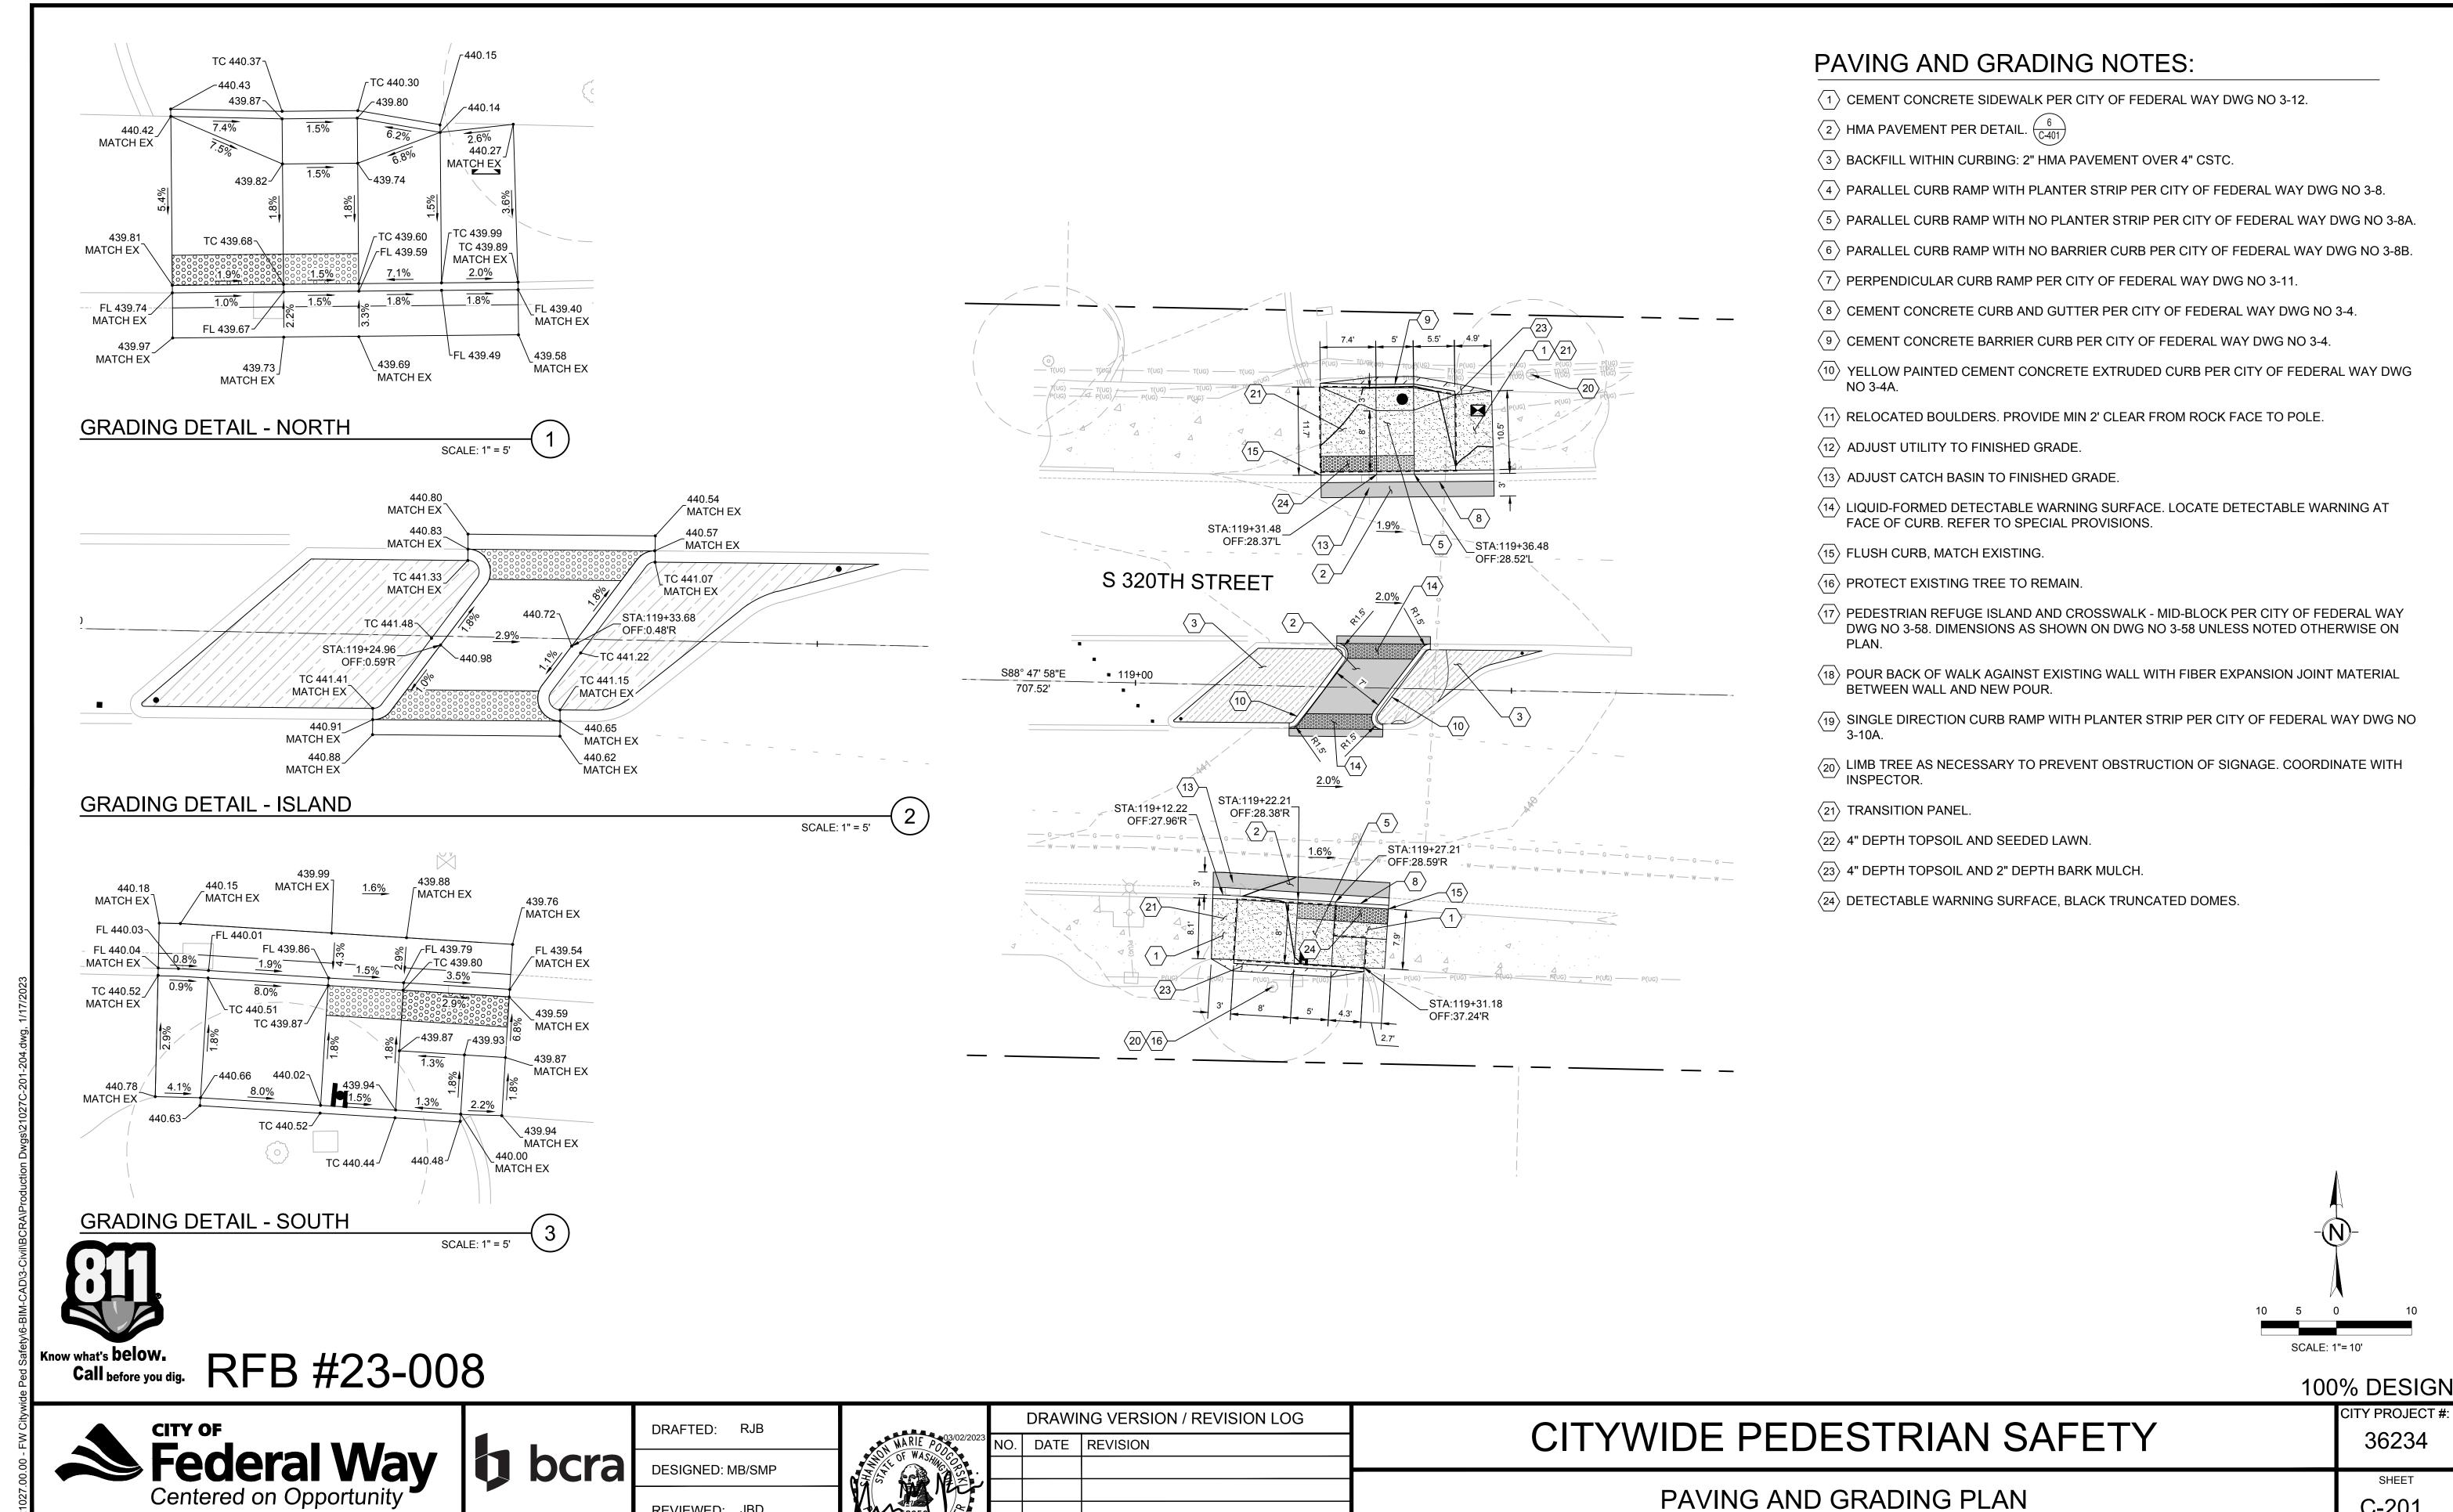
CITYWIDE PEDESTRIAN SAFETY

SITE PREPARATION AND SURVEY CONTROL PLAN LOCATION 8: SW 356TH ST AT 23RD AVE SW

100% DESIGN

36234

C-108



REVIEWED: JBD

APPROVED:

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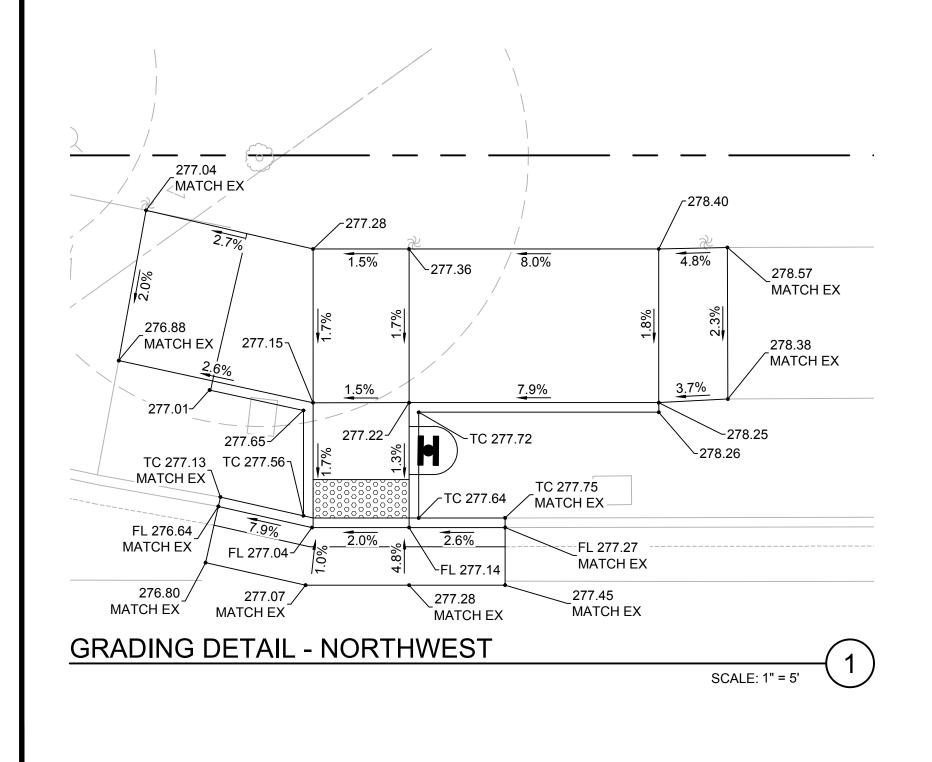
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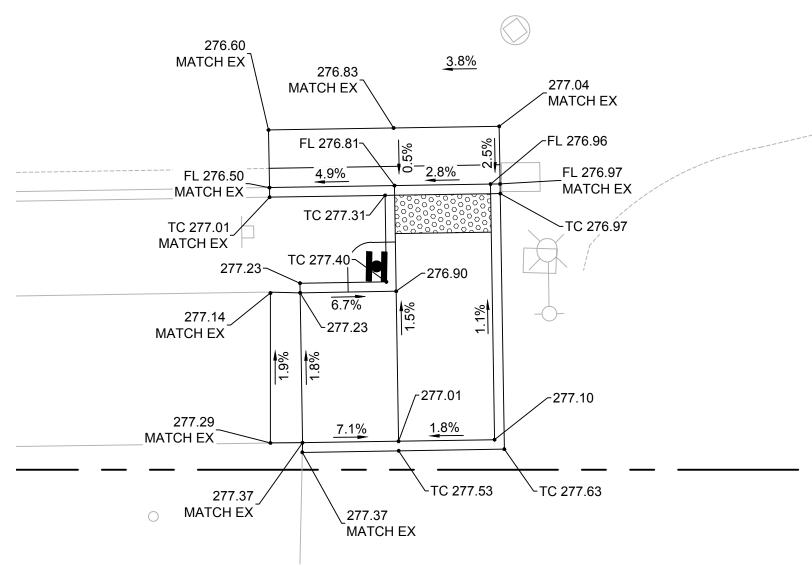
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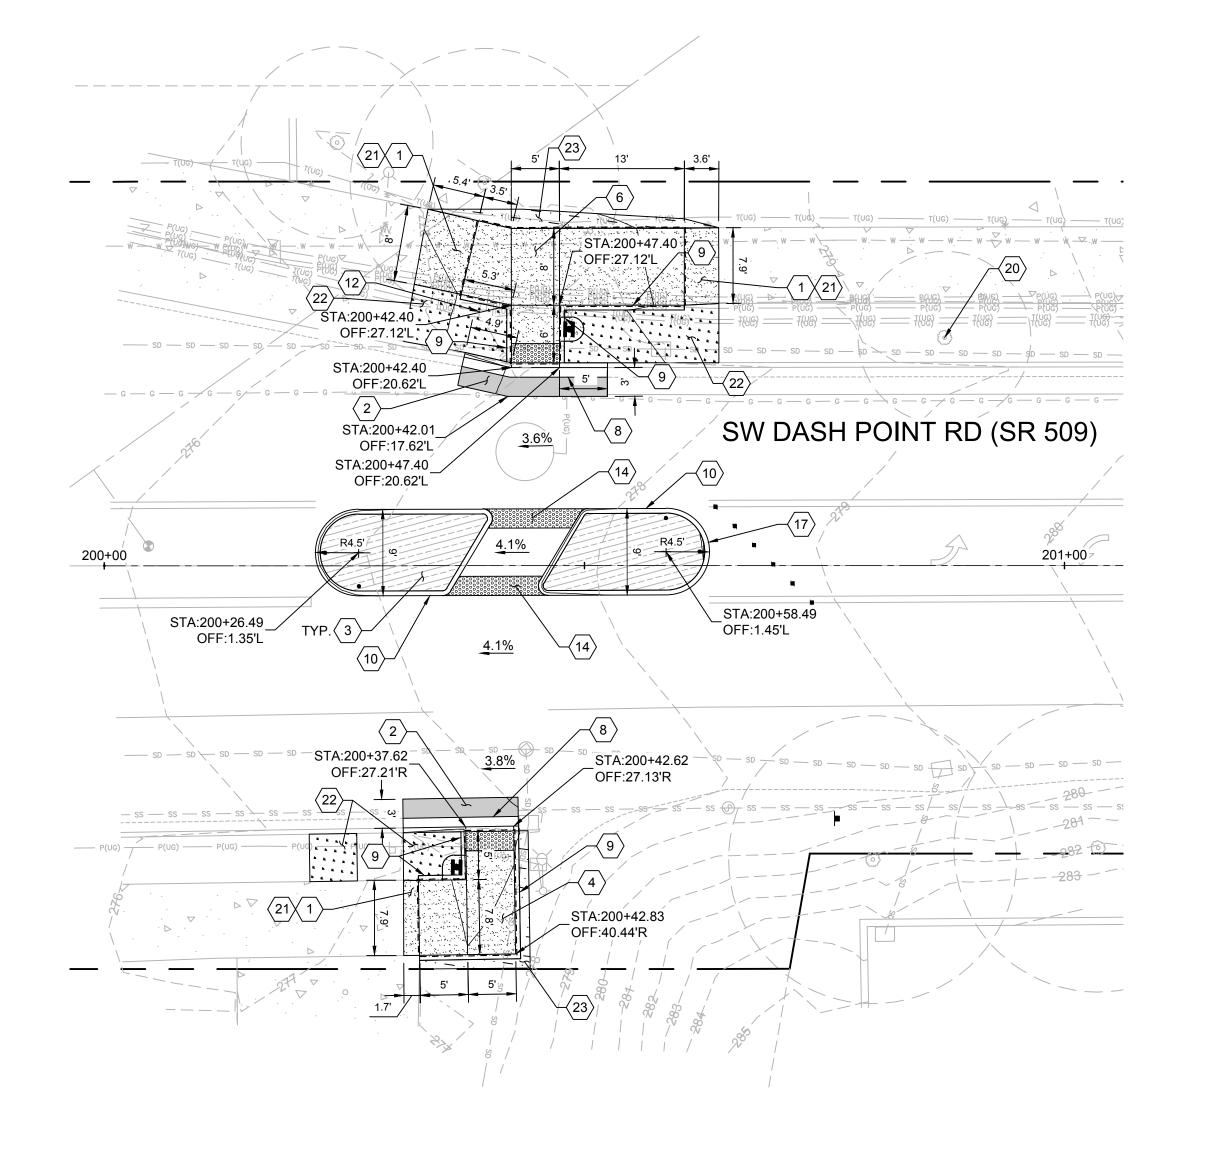
11 of 37

PAVING AND GRADING PLAN

LOCATION 1: S 320TH ST - 1400 BLOCK







PAVING AND GRADING NOTES:

- (1) CEMENT CONCRETE SIDEWALK PER CITY OF FEDERAL WAY DWG NO 3-12.
- $\langle 2 \rangle$ HMA PAVEMENT PER DETAIL.
- (3) BACKFILL WITHIN CURBING: 2" HMA PAVEMENT OVER 4" CSTC.
- 4 PARALLEL CURB RAMP WITH PLANTER STRIP PER CITY OF FEDERAL WAY DWG NO 3-8.
- \langle 5 \rangle PARALLEL CURB RAMP WITH NO PLANTER STRIP PER CITY OF FEDERAL WAY DWG NO 3-8A.
- (6) PARALLEL CURB RAMP WITH NO BARRIER CURB PER CITY OF FEDERAL WAY DWG NO 3-8B.
- 7 PERPENDICULAR CURB RAMP PER CITY OF FEDERAL WAY DWG NO 3-11.
- $\langle 8 \rangle$ CEMENT CONCRETE CURB AND GUTTER PER CITY OF FEDERAL WAY DWG NO 3-4.
- (9) CEMENT CONCRETE BARRIER CURB PER CITY OF FEDERAL WAY DWG NO 3-4.
- (10) YELLOW PAINTED CEMENT CONCRETE EXTRUDED CURB PER CITY OF FEDERAL WAY DWG
- \langle 11 \rangle RELOCATED BOULDERS. PROVIDE MIN 2' CLEAR FROM ROCK FACE TO POLE.
- $\langle 12 \rangle$ ADJUST UTILITY TO FINISHED GRADE.
- (13) ADJUST CATCH BASIN TO FINISHED GRADE.
- \langle 14 \rangle LIQUID-FORMED DETECTABLE WARNING SURFACE. LOCATE DETECTABLE WARNING AT FACE OF CURB. REFER TO SPECIAL PROVISIONS.
- $\langle 15 \rangle$ FLUSH CURB, MATCH EXISTING.
- $\langle 16 \rangle$ PROTECT EXISTING TREE TO REMAIN.
- \langle 17 \rangle PEDESTRIAN REFUGE ISLAND AND CROSSWALK MID-BLOCK PER CITY OF FEDERAL WAY DWG NO 3-58. DIMENSIONS AS SHOWN ON DWG NO 3-58 UNLESS NOTED OTHERWISE ON PLAN.
- $\langle 18
 angle$ POUR BACK OF WALK AGAINST EXISTING WALL WITH FIBER EXPANSION JOINT MATERIAL BETWEEN WALL AND NEW POUR.
- $\left\langle 19 \right\rangle$ SINGLE DIRECTION CURB RAMP WITH PLANTER STRIP PER CITY OF FEDERAL WAY DWG NO
- LIMB TREE AS NECESSARY TO PREVENT OBSTRUCTION OF SIGNAGE. COORDINATE WITH
- (21) TRANSITION PANEL
- (22) 4" DEPTH TOPSOIL AND SEEDED LAWN.
- (23) 4" DEPTH TOPSOIL AND 2" DEPTH BARK MULCH.





Section Federal Way Centered on Opportunity '

33325 8TH AVE S FEDERAL WAY, WA 98003 PHONE: (253) 835-2700 WWW.CITYOFFEDERALWAY.COM

bcra

DRAFTED: RJB

DESIGNED: MB/SMP

REVIEWED: JBD

APPROVED:

T 253.627.4367 F 253.627.4395 WWW.BCRADESIGN.COM



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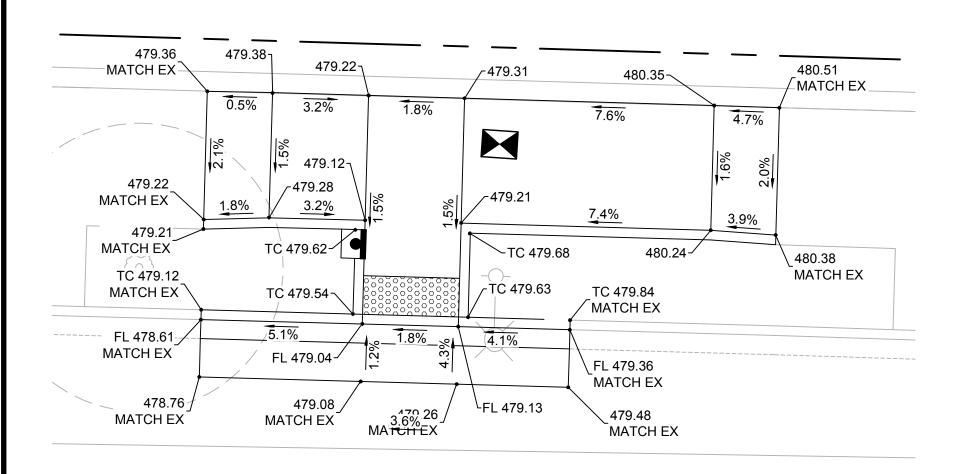
CITYWIDE PEDESTRIAN SAFETY

PAVING AND GRADING PLAN LOCATION 2: SR 509 SOUTH OF 16TH AVE SW

100% DESIGN


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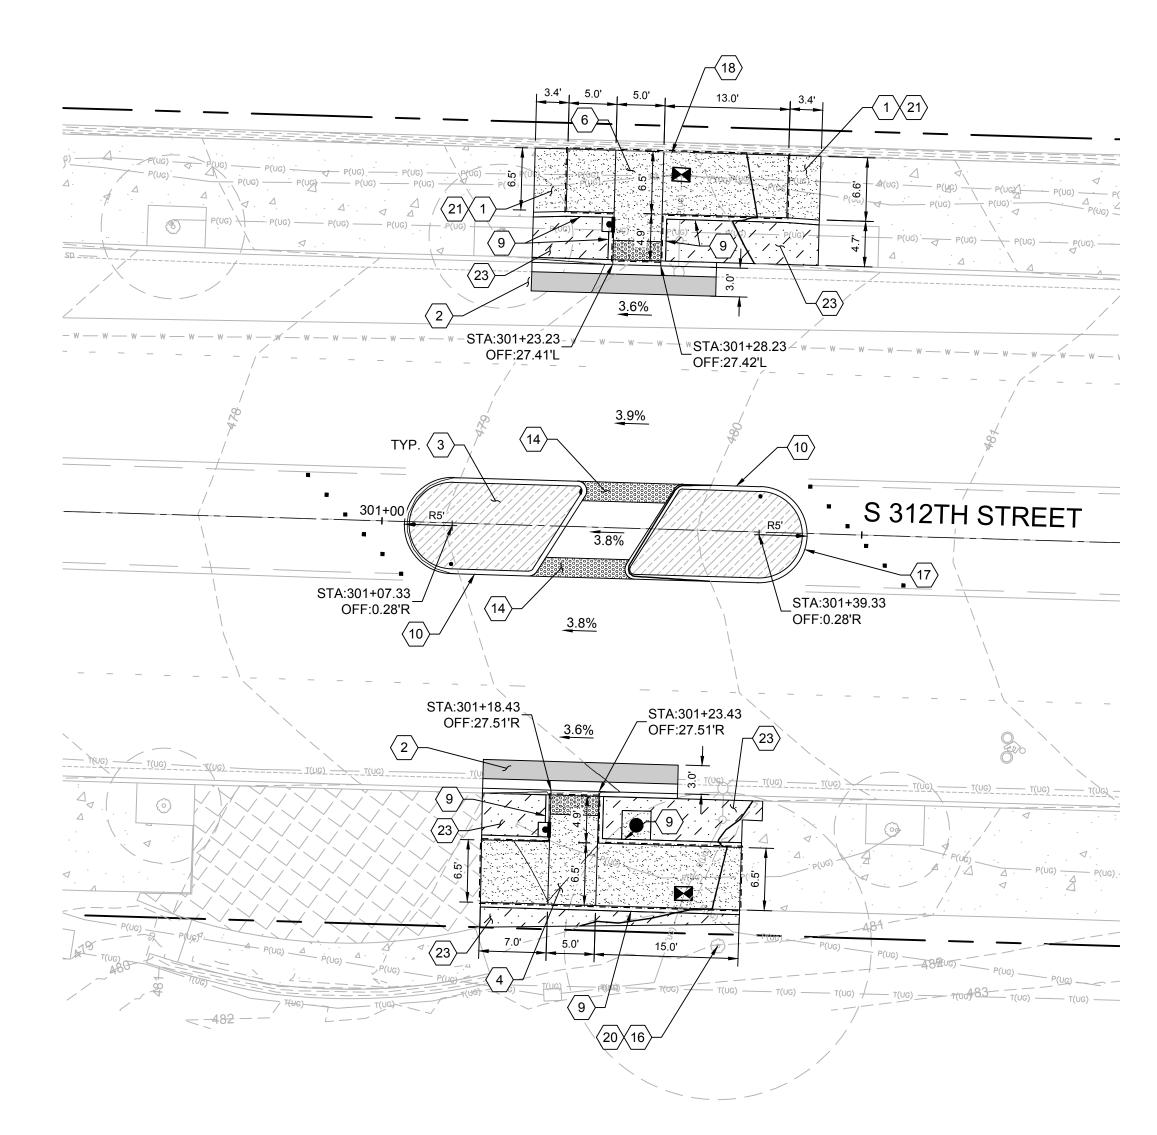
GRADING DETAIL - NORTH

SCALE: 1" = 5'



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RFB #23-008

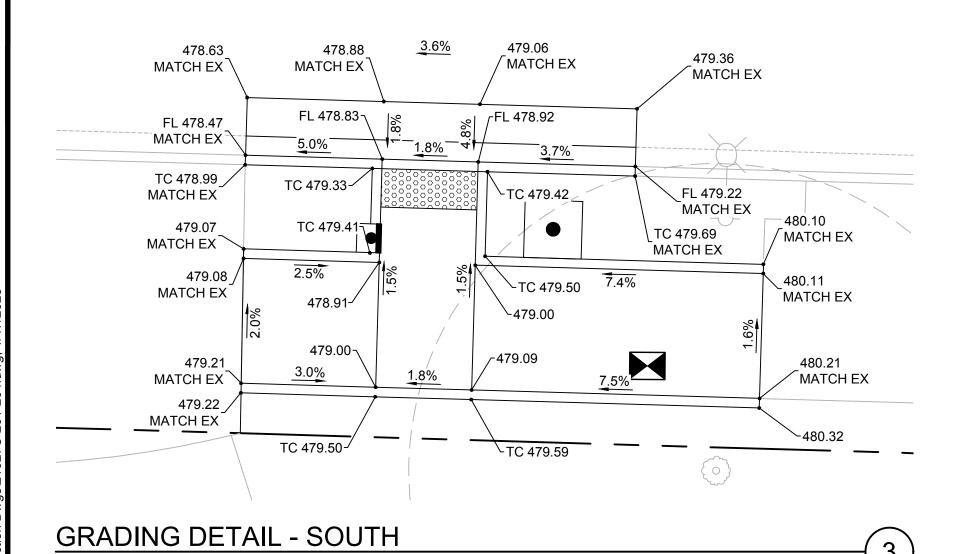

PAVING AND GRADING NOTES:

- (1) CEMENT CONCRETE SIDEWALK PER CITY OF FEDERAL WAY DWG NO 3-12.
- (2) HMA PAVEMENT PER DETAIL.
- (3) BACKFILL WITHIN CURBING: 2" HMA PAVEMENT OVER 4" CSTC.
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- $\langle 5 \rangle$ PARALLEL CURB RAMP WITH NO PLANTER STRIP PER CITY OF FEDERAL WAY DWG NO 3-8A.
- $\langle 6 \rangle$ PARALLEL CURB RAMP WITH NO BARRIER CURB PER CITY OF FEDERAL WAY DWG NO 3-8B.
- 7 PERPENDICULAR CURB RAMP PER CITY OF FEDERAL WAY DWG NO 3-11.
- $\langle 8 \rangle$ CEMENT CONCRETE CURB AND GUTTER PER CITY OF FEDERAL WAY DWG NO 3-4.
- (9) CEMENT CONCRETE BARRIER CURB PER CITY OF FEDERAL WAY DWG NO 3-4.
- (10) YELLOW PAINTED CEMENT CONCRETE EXTRUDED CURB PER CITY OF FEDERAL WAY DWG
- \langle 11 \rangle RELOCATED BOULDERS. PROVIDE MIN 2' CLEAR FROM ROCK FACE TO POLE.
- (12) ADJUST UTILITY TO FINISHED GRADE.
- (13) ADJUST CATCH BASIN TO FINISHED GRADE.
- \langle 14 \rangle LIQUID-FORMED DETECTABLE WARNING SURFACE. LOCATE DETECTABLE WARNING AT FACE OF CURB. REFER TO SPECIAL PROVISIONS.
- (15) FLUSH CURB, MATCH EXISTING.
- $\langle 16 \rangle$ PROTECT EXISTING TREE TO REMAIN.
- \langle 17 \rangle PEDESTRIAN REFUGE ISLAND AND CROSSWALK MID-BLOCK PER CITY OF FEDERAL WAY DWG NO 3-58. DIMENSIONS AS SHOWN ON DWG NO 3-58 UNLESS NOTED OTHERWISE ON PLAN.
- $\langle 18
 angle$ POUR BACK OF WALK AGAINST EXISTING WALL WITH FIBER EXPANSION JOINT MATERIAL BETWEEN WALL AND NEW POUR.
- \langle 19 \rangle SINGLE DIRECTION CURB RAMP WITH PLANTER STRIP PER CITY OF FEDERAL WAY DWG NO
- $\langle 20
 angle$ LIMB TREE AS NECESSARY TO PREVENT OBSTRUCTION OF SIGNAGE. COORDINATE WITH
- (21) TRANSITION PANEL
- $\langle 22 \rangle$ 4" DEPTH TOPSOIL AND SEEDED LAWN.
- (23) 4" DEPTH TOPSOIL AND 2" DEPTH BARK MULCH.
- (24) DETECTABLE WARNING SURFACE, BLACK TRUNCATED DOMES.

100% DESIGN




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DRAFTED: RJB




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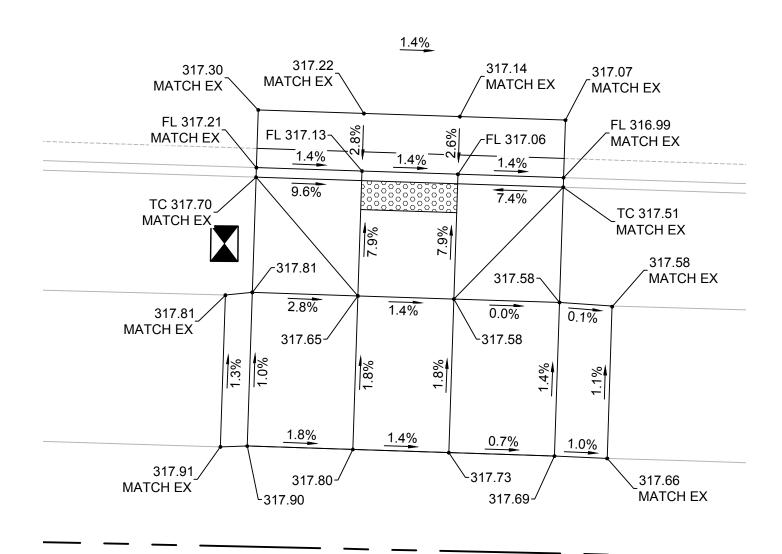
CITYWIDE PEDESTRIAN SAFETY

PAVING AND GRADING PLAN LOCATION 3: S 312TH ST AT 18TH AVE S 36234

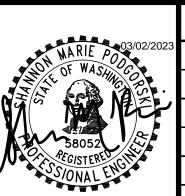C-203

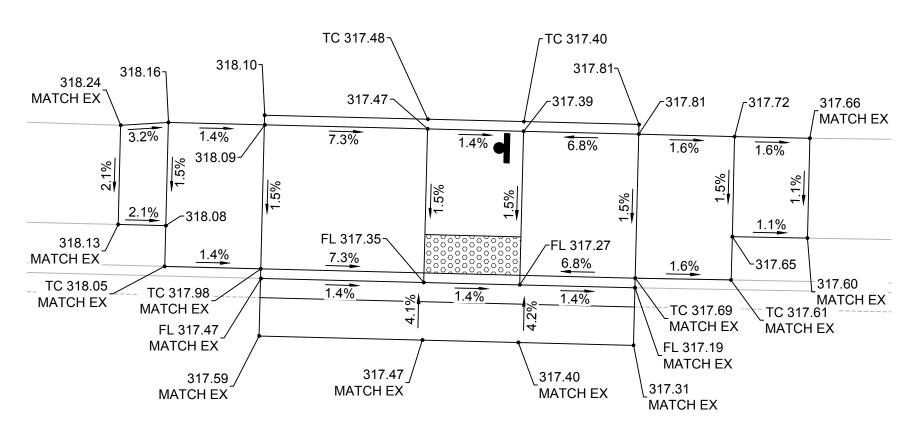


GRADING DETAIL - NORTH SCALE: 1" = 5'



GRADING DETAIL - SOUTH




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Call before you dig. RFB #23-008

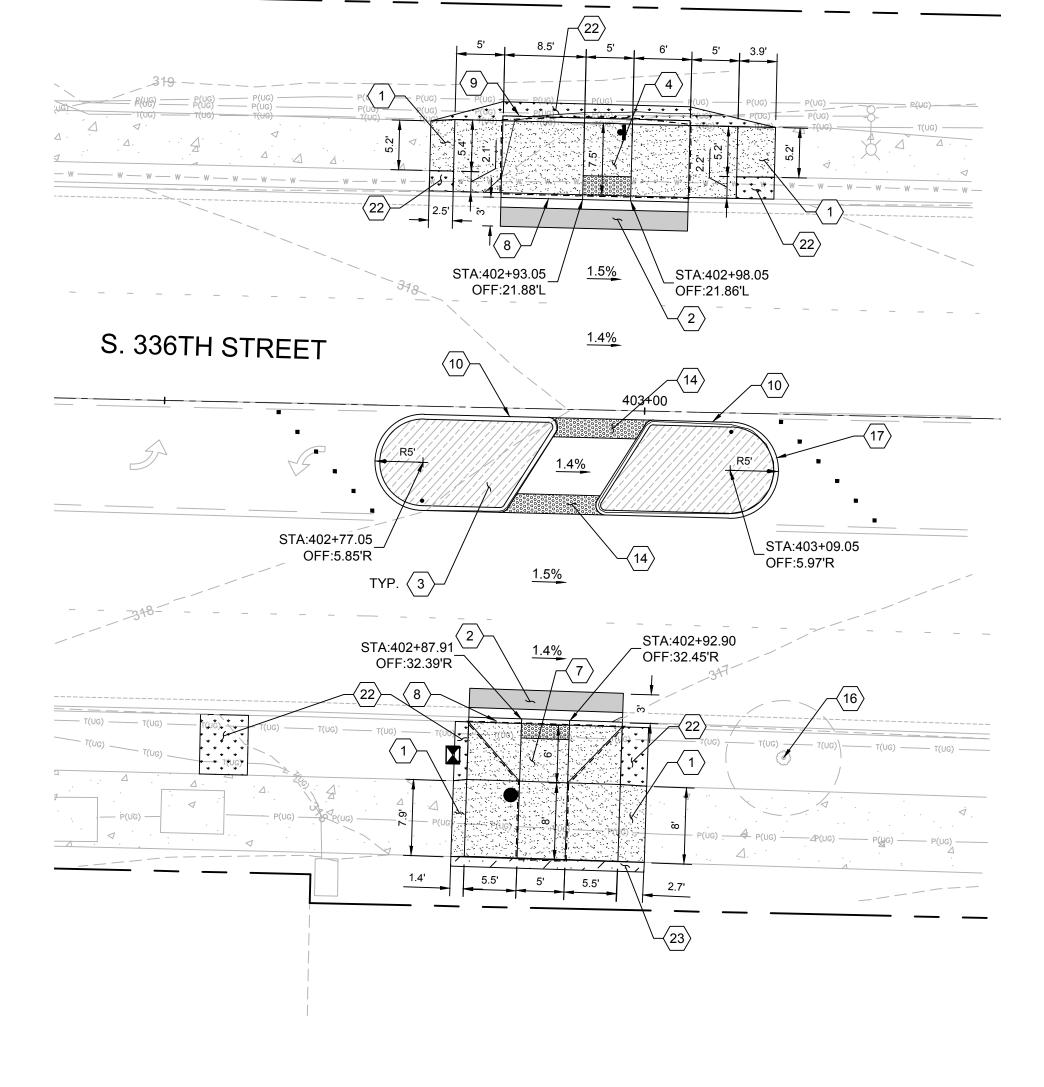

PAVING AND GRADING NOTES:

- (1) CEMENT CONCRETE SIDEWALK PER CITY OF FEDERAL WAY DWG NO 3-12.
- (2) HMA PAVEMENT PER DETAIL.
- (3) BACKFILL WITHIN CURBING: 2" HMA PAVEMENT OVER 4" CSTC.
- 4 PARALLEL CURB RAMP WITH PLANTER STRIP PER CITY OF FEDERAL WAY DWG NO 3-8.
- $\langle 5 \rangle$ PARALLEL CURB RAMP WITH NO PLANTER STRIP PER CITY OF FEDERAL WAY DWG NO 3-8A.
- (6) PARALLEL CURB RAMP WITH NO BARRIER CURB PER CITY OF FEDERAL WAY DWG NO 3-8B.
- $\langle 7 \rangle$ PERPENDICULAR CURB RAMP PER CITY OF FEDERAL WAY DWG NO 3-11.
- $\langle 8 \rangle$ CEMENT CONCRETE CURB AND GUTTER PER CITY OF FEDERAL WAY DWG NO 3-4.
- (9) CEMENT CONCRETE BARRIER CURB PER CITY OF FEDERAL WAY DWG NO 3-4.
- (10) YELLOW PAINTED CEMENT CONCRETE EXTRUDED CURB PER CITY OF FEDERAL WAY DWG
- \langle 11 \rangle RELOCATED BOULDERS. PROVIDE MIN 2' CLEAR FROM ROCK FACE TO POLE.
- $\langle 12 \rangle$ ADJUST UTILITY TO FINISHED GRADE.
- $\langle 13 \rangle$ ADJUST CATCH BASIN TO FINISHED GRADE.
- \langle 14 \rangle LIQUID-FORMED DETECTABLE WARNING SURFACE. LOCATE DETECTABLE WARNING AT FACE OF CURB. REFER TO SPECIAL PROVISIONS.
- (15) FLUSH CURB, MATCH EXISTING.
- $\langle 16 \rangle$ PROTECT EXISTING TREE TO REMAIN.
- \langle 17 \rangle PEDESTRIAN REFUGE ISLAND AND CROSSWALK MID-BLOCK PER CITY OF FEDERAL WAY DWG NO 3-58. DIMENSIONS AS SHOWN ON DWG NO 3-58 UNLESS NOTED OTHERWISE ON
- $\langle 18
 angle$ POUR BACK OF WALK AGAINST EXISTING WALL WITH FIBER EXPANSION JOINT MATERIAL BETWEEN WALL AND NEW POUR.
- $\left\langle 19 \right\rangle$ SINGLE DIRECTION CURB RAMP WITH PLANTER STRIP PER CITY OF FEDERAL WAY DWG NO
- $\stackrel{\textstyle \frown}{}$ LIMB TREE AS NECESSARY TO PREVENT OBSTRUCTION OF SIGNAGE. COORDINATE WITH INSPECTOR.
- (21) TRANSITION PANEL
- (22) 4" DEPTH TOPSOIL AND SEEDED LAWN.
- (23) 4" DEPTH TOPSOIL AND 2" DEPTH BARK MULCH.

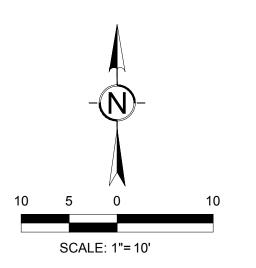

100% DESIGN




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DESIGNED: MB/SMP REVIEWED: JBD T 253.627.4367 F 253.627.4395 APPROVED: WWW.BCRADESIGN.COM

DRAFTED: RJB





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CITYWIDE PEDESTRIAN SAFETY

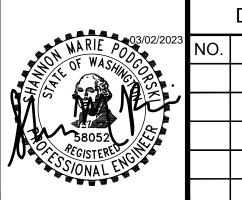PAVING AND GRADING PLAN LOCATION 4: S 336TH ST AT 10TH PL S 36234

C-204



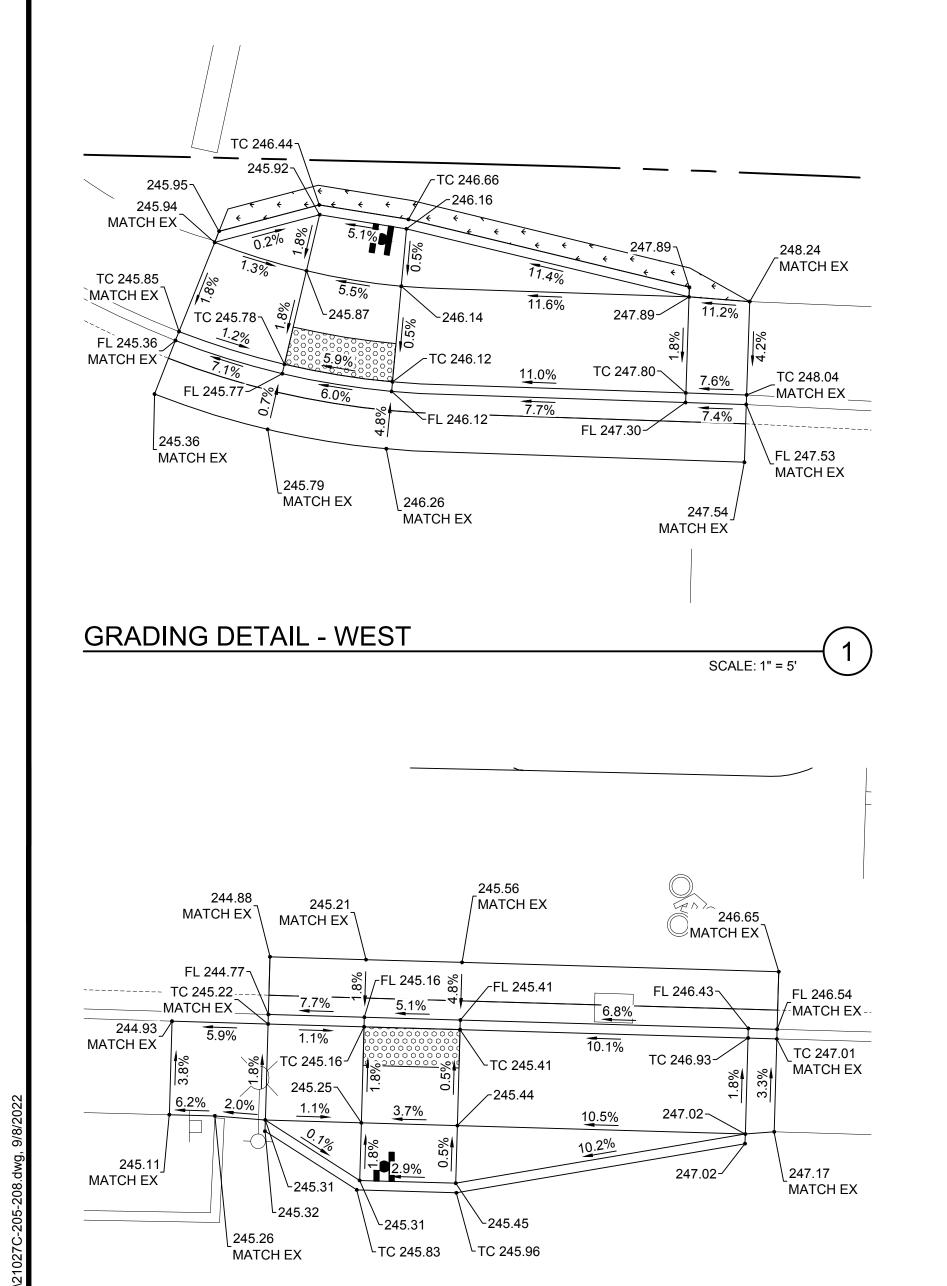

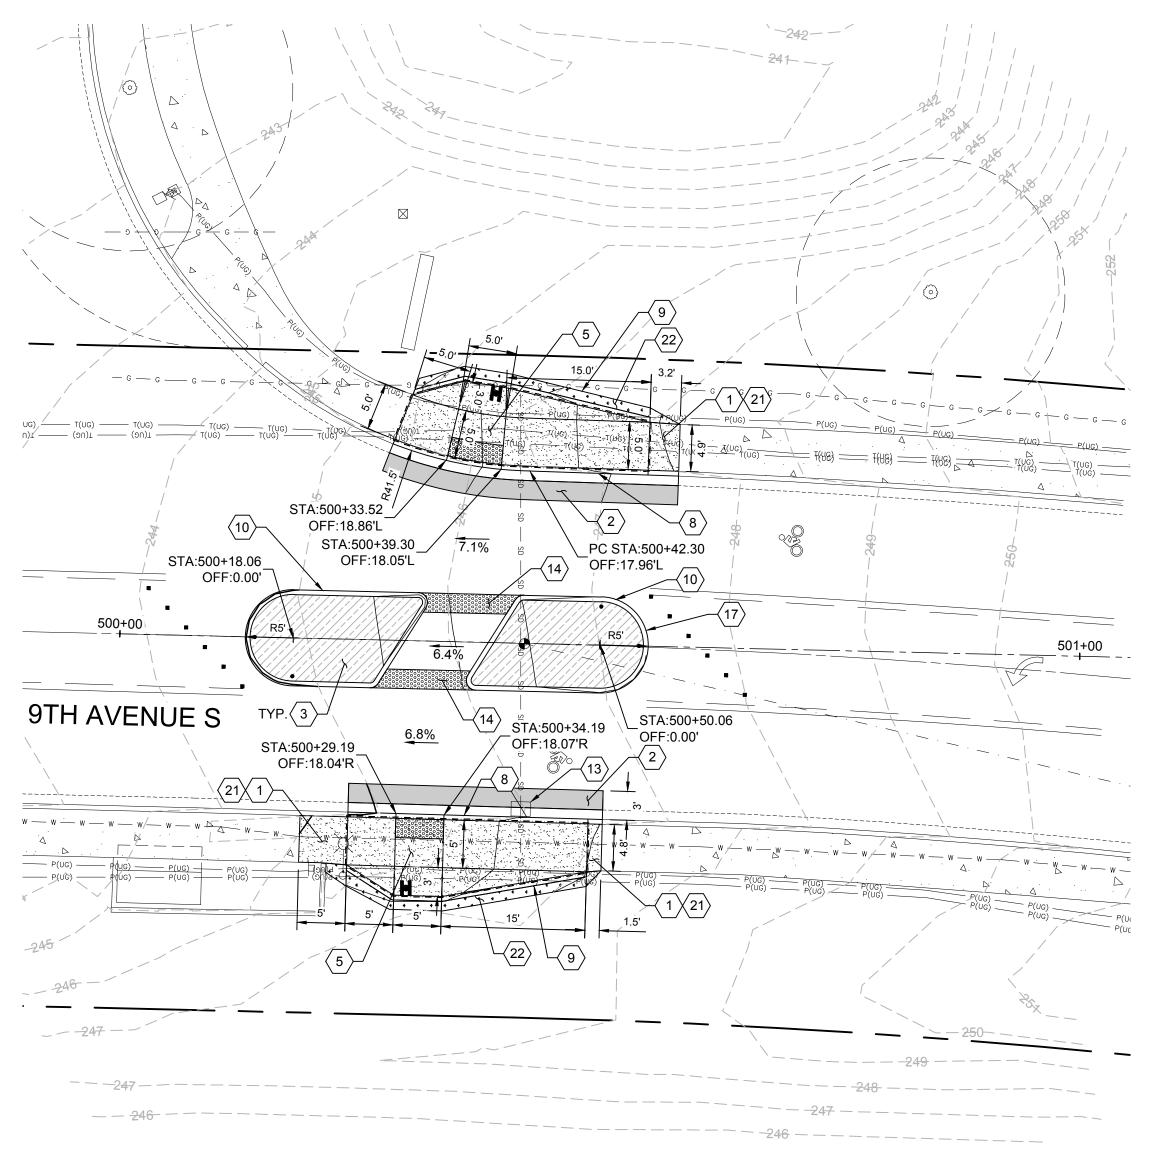PAVING AND GRADING NOTES:

- (1) CEMENT CONCRETE SIDEWALK PER CITY OF FEDERAL WAY DWG NO 3-12.
- $\langle 2 \rangle$ HMA PAVEMENT PER DETAIL.
- (3) BACKFILL WITHIN CURBING: 2" HMA PAVEMENT OVER 4" CSTC.
- 4 PARALLEL CURB RAMP WITH PLANTER STRIP PER CITY OF FEDERAL WAY DWG NO 3-8.
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- (6) PARALLEL CURB RAMP WITH NO BARRIER CURB PER CITY OF FEDERAL WAY DWG NO 3-8B.
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- $\langle 16 \rangle$ PROTECT EXISTING TREE TO REMAIN.
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- \langle 19 \rangle SINGLE DIRECTION CURB RAMP WITH PLANTER STRIP PER CITY OF FEDERAL WAY DWG NO
- (20) LIMB TREE AS NECESSARY TO PREVENT OBSTRUCTION OF SIGNAGE. COORDINATE WITH
- (21) TRANSITION PANEL
- $\langle 22 \rangle$ 4" DEPTH TOPSOIL AND SEEDED LAWN.
- (23) 4" DEPTH TOPSOIL AND 2" DEPTH BARK MULCH.



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GRADING DETAIL - EAST

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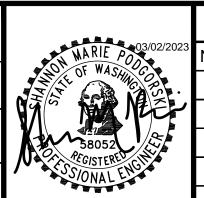
DRAFTED: RJB

DESIGNED: MB/SMP

REVIEWED: JBD

APPROVED:

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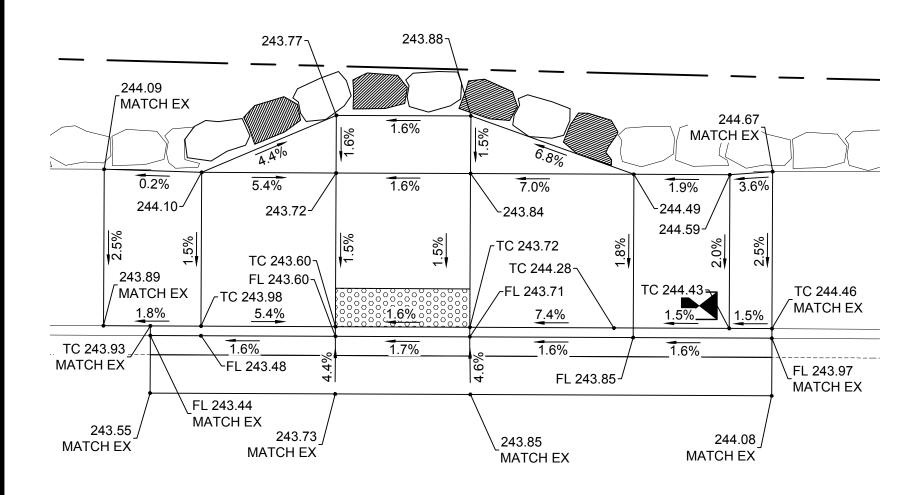
CITYWIDE PEDESTRIAN SAFETY

PAVING AND GRADING PLAN LOCATION 5: 9TH AVE S AT ST. FRANCIS HOSPITAL


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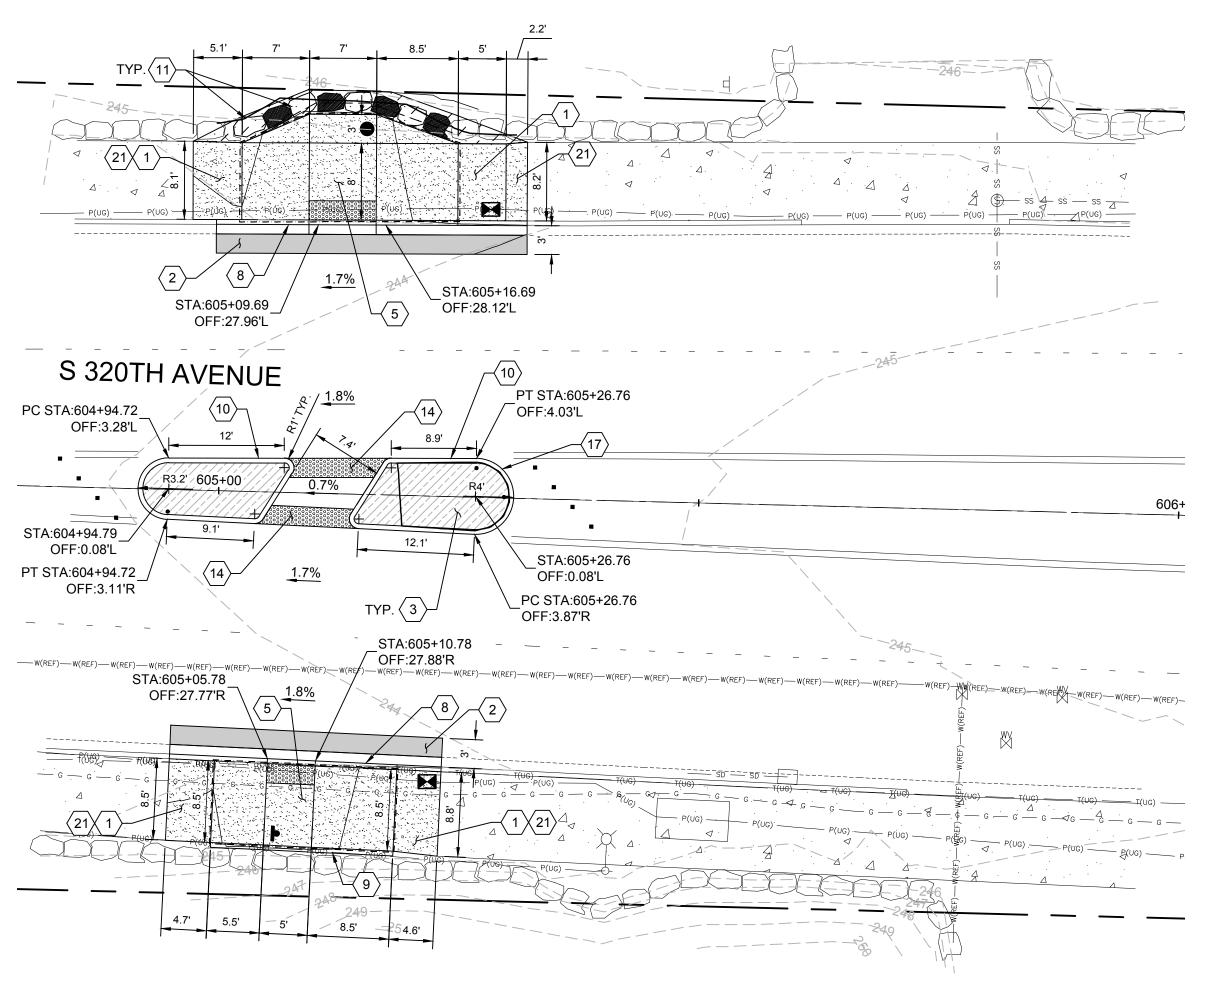
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C-205



GRADING DETAIL - NORTH SCALE: 1" = 5'



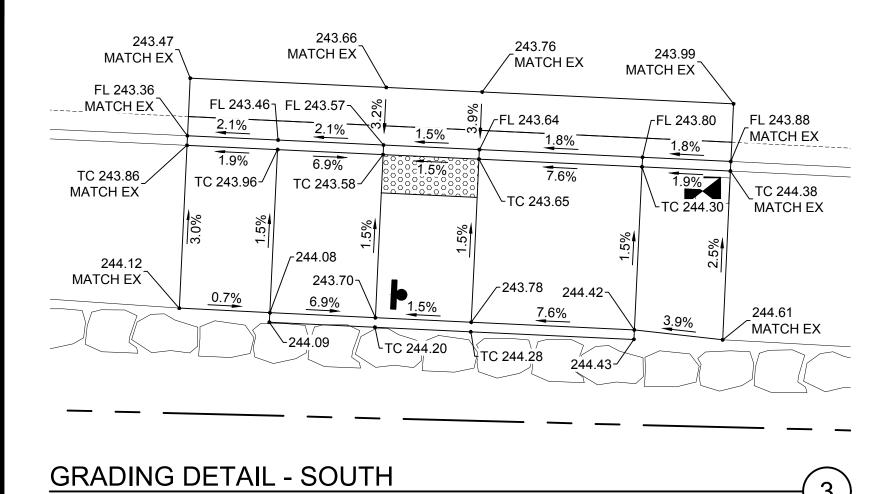

PAVING AND GRADING NOTES:

- (1) CEMENT CONCRETE SIDEWALK PER CITY OF FEDERAL WAY DWG NO 3-12.
- (2) HMA PAVEMENT PER DETAIL.
- (3) BACKFILL WITHIN CURBING: 2" HMA PAVEMENT OVER 4" CSTC.
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- (6) PARALLEL CURB RAMP WITH NO BARRIER CURB PER CITY OF FEDERAL WAY DWG NO 3-8B.
- 7 PERPENDICULAR CURB RAMP PER CITY OF FEDERAL WAY DWG NO 3-11.
- $\langle 8 \rangle$ CEMENT CONCRETE CURB AND GUTTER PER CITY OF FEDERAL WAY DWG NO 3-4.
- (9) CEMENT CONCRETE BARRIER CURB PER CITY OF FEDERAL WAY DWG NO 3-4.
- (10) YELLOW PAINTED CEMENT CONCRETE EXTRUDED CURB PER CITY OF FEDERAL WAY DWG
- \langle 11 \rangle RELOCATED BOULDERS. PROVIDE MIN 2' CLEAR FROM ROCK FACE TO POLE.
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- $\langle 13 \rangle$ ADJUST CATCH BASIN TO FINISHED GRADE.
- \langle 14 \rangle LIQUID-FORMED DETECTABLE WARNING SURFACE. LOCATE DETECTABLE WARNING AT FACE OF CURB. REFER TO SPECIAL PROVISIONS.
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- $\langle \overline{20}
 angle$ LIMB TREE AS NECESSARY TO PREVENT OBSTRUCTION OF SIGNAGE. COORDINATE WITH
- (21) TRANSITION PANEL
- $\langle 22 \rangle$ 4" DEPTH TOPSOIL AND SEEDED LAWN.
- $\langle 23 \rangle$ 4" DEPTH TOPSOIL AND 2" DEPTH BARK MULCH.
- (24) DETECTABLE WARNING SURFACE, BLACK TRUNCATED DOMES.



Know what's below.
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RFB #23-008

CITY OF Section Federal Way Centered on Opportunity 33325 8TH AVE S FEDERAL WAY, WA 98003

PHONE: (253) 835-2700

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WWW.BCRADESIGN.COM

DESIGNED: MB/SMP

DRAFTED: RJB

REVIEWED: JBD

APPROVED:

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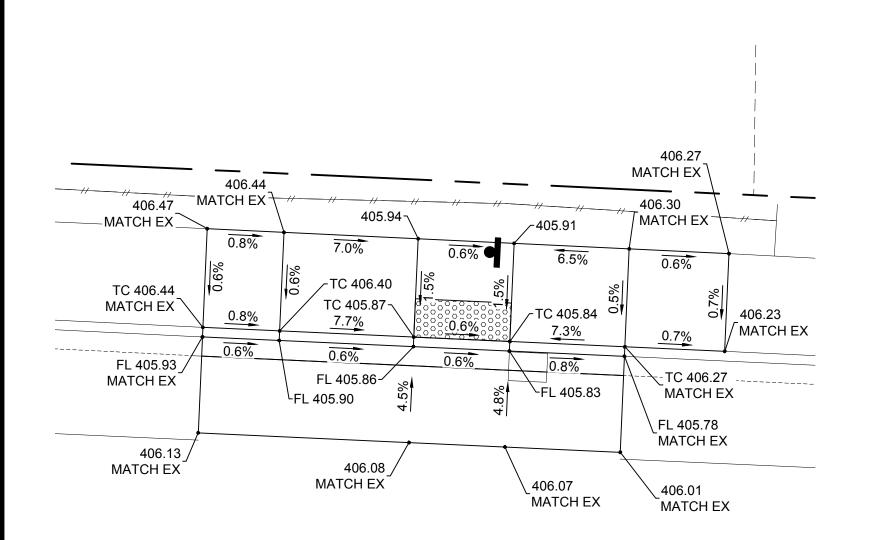
CITYWIDE PEDESTRIAN SAFETY

PAVING AND GRADING PLAN LOCATION 6: SW 320TH ST AT 45TH PL SW


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GRADING DETAIL - NORTH SCALE: 1" = 5'



GRADING DETAIL - SOUTH



Know what's below.
Call before you dig.

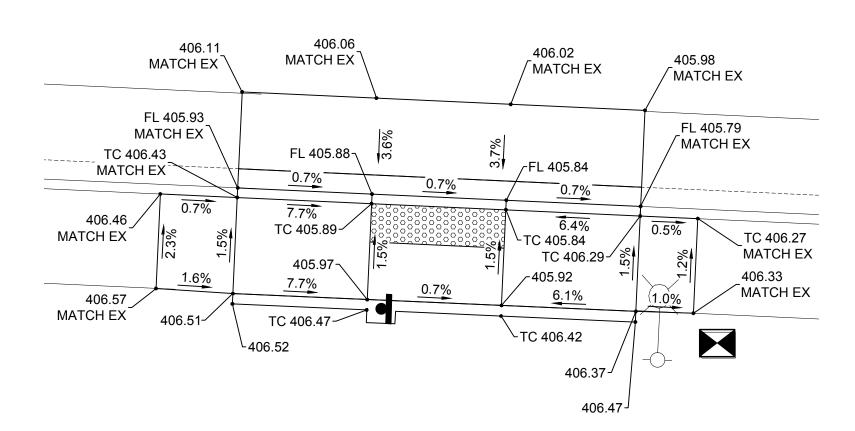
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4.0' 7.0' 5.0' 6.0' 5.2'

PAVING AND GRADING NOTES:

- (1) CEMENT CONCRETE SIDEWALK PER CITY OF FEDERAL WAY DWG NO 3-12.
- (2) HMA PAVEMENT PER DETAIL.
- (3) BACKFILL WITHIN CURBING: 2" HMA PAVEMENT OVER 4" CSTC.
- 4 PARALLEL CURB RAMP WITH PLANTER STRIP PER CITY OF FEDERAL WAY DWG NO 3-8.
- \langle 5 \rangle PARALLEL CURB RAMP WITH NO PLANTER STRIP PER CITY OF FEDERAL WAY DWG NO 3-8A.
- (6) PARALLEL CURB RAMP WITH NO BARRIER CURB PER CITY OF FEDERAL WAY DWG NO 3-8B.
- $\langle 7 \rangle$ PERPENDICULAR CURB RAMP PER CITY OF FEDERAL WAY DWG NO 3-11.
- $\langle 8 \rangle$ CEMENT CONCRETE CURB AND GUTTER PER CITY OF FEDERAL WAY DWG NO 3-4.
- (9) CEMENT CONCRETE BARRIER CURB PER CITY OF FEDERAL WAY DWG NO 3-4.
- (10) YELLOW PAINTED CEMENT CONCRETE EXTRUDED CURB PER CITY OF FEDERAL WAY DWG
- \langle 11 \rangle RELOCATED BOULDERS. PROVIDE MIN 2' CLEAR FROM ROCK FACE TO POLE.
- $\langle 12 \rangle$ ADJUST UTILITY TO FINISHED GRADE.
- $\langle 13 \rangle$ ADJUST CATCH BASIN TO FINISHED GRADE.
- \langle 14 \rangle LIQUID-FORMED DETECTABLE WARNING SURFACE. LOCATE DETECTABLE WARNING AT FACE OF CURB. REFER TO SPECIAL PROVISIONS.
- $\langle 15 \rangle$ FLUSH CURB, MATCH EXISTING.
- $\langle 16 \rangle$ PROTECT EXISTING TREE TO REMAIN.
- \langle 17 \rangle PEDESTRIAN REFUGE ISLAND AND CROSSWALK MID-BLOCK PER CITY OF FEDERAL WAY DWG NO 3-58. DIMENSIONS AS SHOWN ON DWG NO 3-58 UNLESS NOTED OTHERWISE ON PLAN.
- $\langle 18
 angle$ POUR BACK OF WALK AGAINST EXISTING WALL WITH FIBER EXPANSION JOINT MATERIAL BETWEEN WALL AND NEW POUR.
- \langle 19 \rangle SINGLE DIRECTION CURB RAMP WITH PLANTER STRIP PER CITY OF FEDERAL WAY DWG NO
- $\langle \overline{20}
 angle$ LIMB TREE AS NECESSARY TO PREVENT OBSTRUCTION OF SIGNAGE. COORDINATE WITH
- (21) TRANSITION PANEL
- $\langle 22 \rangle$ 4" DEPTH TOPSOIL AND SEEDED LAWN.
- $\langle 23 \rangle$ 4" DEPTH TOPSOIL AND 2" DEPTH BARK MULCH.




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DRAFTED: RJB **1** bcra
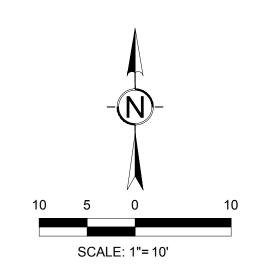
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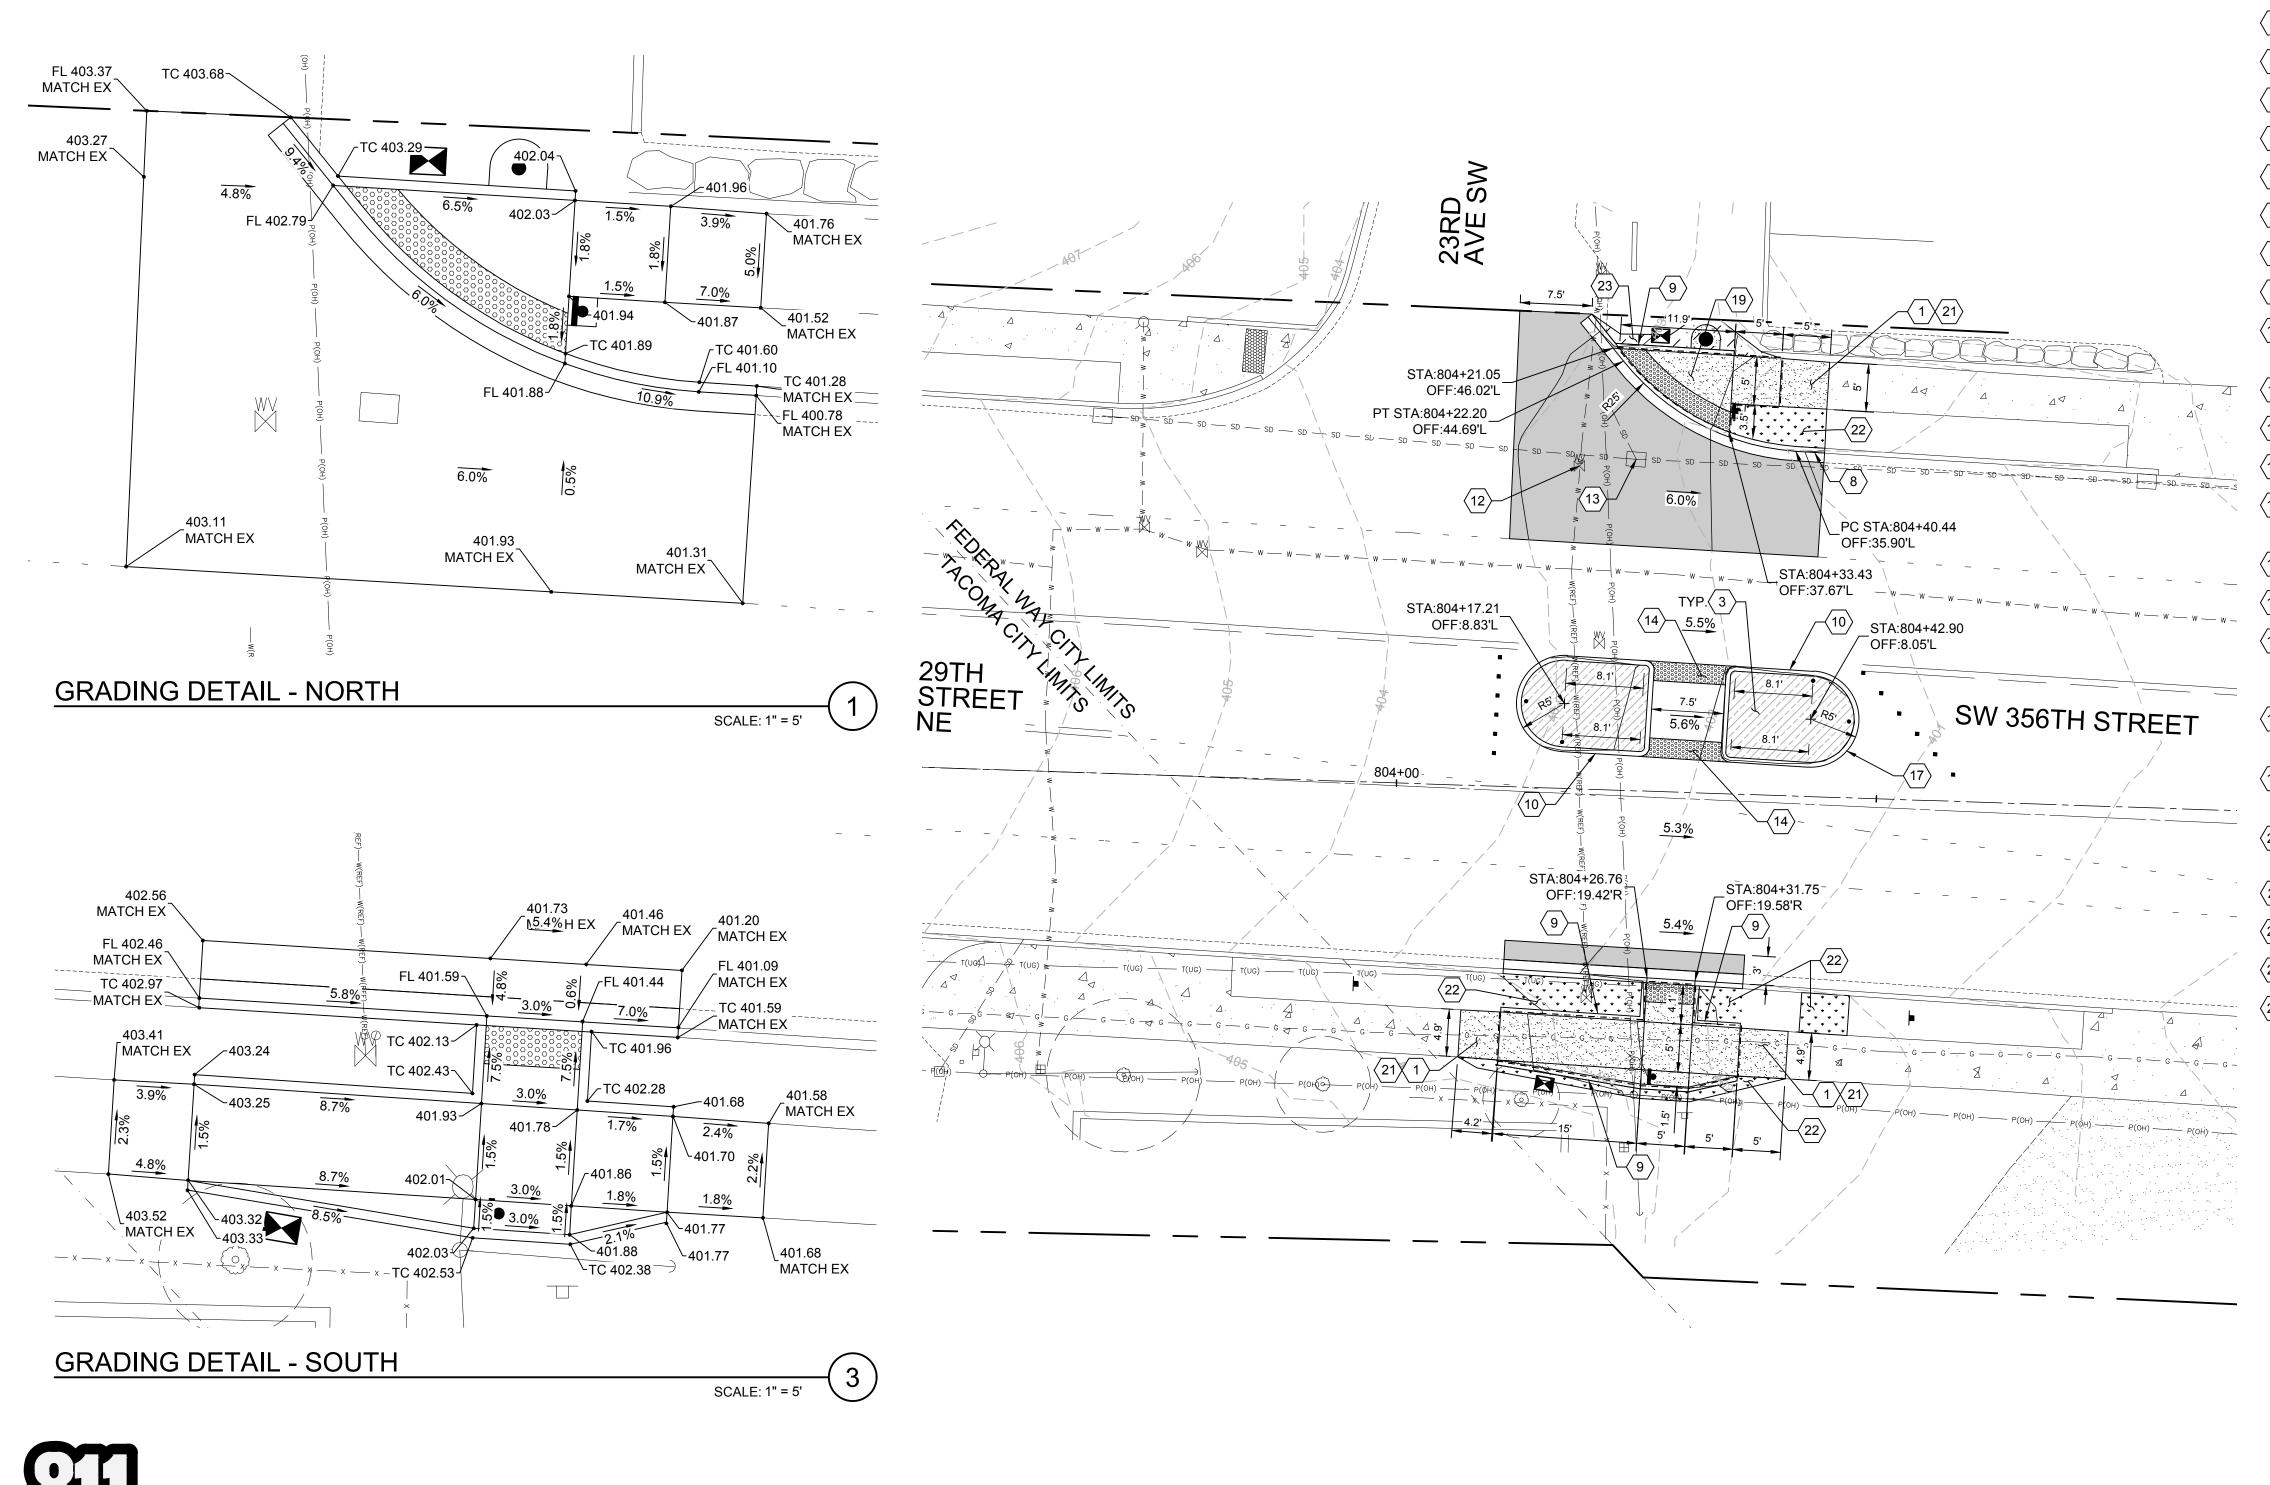
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CITYWIDE PEDESTRIAN SAFETY

PAVING AND GRADING PLAN LOCATION 7: SW 356TH ST AT 18TH AVE SW 36234

C-207

17 OF 37

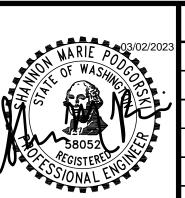

PAVING AND GRADING NOTES:

- (1) CEMENT CONCRETE SIDEWALK PER CITY OF FEDERAL WAY DWG NO 3-12.
- (2) HMA PAVEMENT PER DETAIL.
- (3) BACKFILL WITHIN CURBING: 2" HMA PAVEMENT OVER 4" CSTC.
- 4 PARALLEL CURB RAMP WITH PLANTER STRIP PER CITY OF FEDERAL WAY DWG NO 3-8.
- (5) PARALLEL CURB RAMP WITH NO PLANTER STRIP PER CITY OF FEDERAL WAY DWG NO 3-8A.
- (6) PARALLEL CURB RAMP WITH NO BARRIER CURB PER CITY OF FEDERAL WAY DWG NO 3-8B.
- $\langle 7 \rangle$ PERPENDICULAR CURB RAMP PER CITY OF FEDERAL WAY DWG NO 3-11.
- $\langle 8 \rangle$ CEMENT CONCRETE CURB AND GUTTER PER CITY OF FEDERAL WAY DWG NO 3-4.
- (9) CEMENT CONCRETE BARRIER CURB PER CITY OF FEDERAL WAY DWG NO 3-4.
- (10) YELLOW PAINTED CEMENT CONCRETE EXTRUDED CURB PER CITY OF FEDERAL WAY DWG
- \langle 11 \rangle RELOCATED BOULDERS. PROVIDE MIN 2' CLEAR FROM ROCK FACE TO POLE.
- $\langle 12 \rangle$ ADJUST UTILITY TO FINISHED GRADE.
- (13) ADJUST CATCH BASIN TO FINISHED GRADE.
- \langle 14 \rangle LIQUID-FORMED DETECTABLE WARNING SURFACE. LOCATE DETECTABLE WARNING AT FACE OF CURB. REFER TO SPECIAL PROVISIONS.
- \langle 15 \rangle FLUSH CURB, MATCH EXISTING.
- $\langle 16 \rangle$ PROTECT EXISTING TREE TO REMAIN.
- \langle 17 \rangle PEDESTRIAN REFUGE ISLAND AND CROSSWALK MID-BLOCK PER CITY OF FEDERAL WAY DWG NO 3-58. DIMENSIONS AS SHOWN ON DWG NO 3-58 UNLESS NOTED OTHERWISE ON PLAN.
- $\langle 18
 angle$ POUR BACK OF WALK AGAINST EXISTING WALL WITH FIBER EXPANSION JOINT MATERIAL BETWEEN WALL AND NEW POUR.
- \langle 19 \rangle SINGLE DIRECTION CURB RAMP WITH PLANTER STRIP PER CITY OF FEDERAL WAY DWG NO
- $\langle \overline{20} \rangle$ LIMB TREE AS NECESSARY TO PREVENT OBSTRUCTION OF SIGNAGE. COORDINATE WITH
- (21) TRANSITION PANEL
- $\langle 22 \rangle$ 4" DEPTH TOPSOIL AND SEEDED LAWN.
- $\langle 23 \rangle$ 4" DEPTH TOPSOIL AND 2" DEPTH BARK MULCH.

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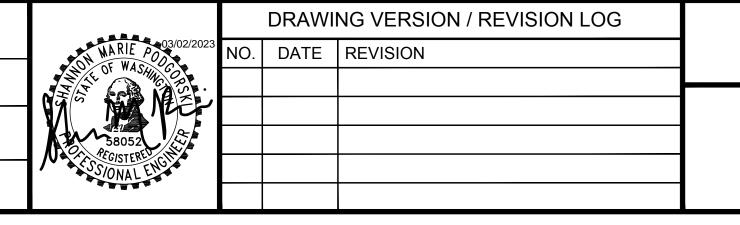
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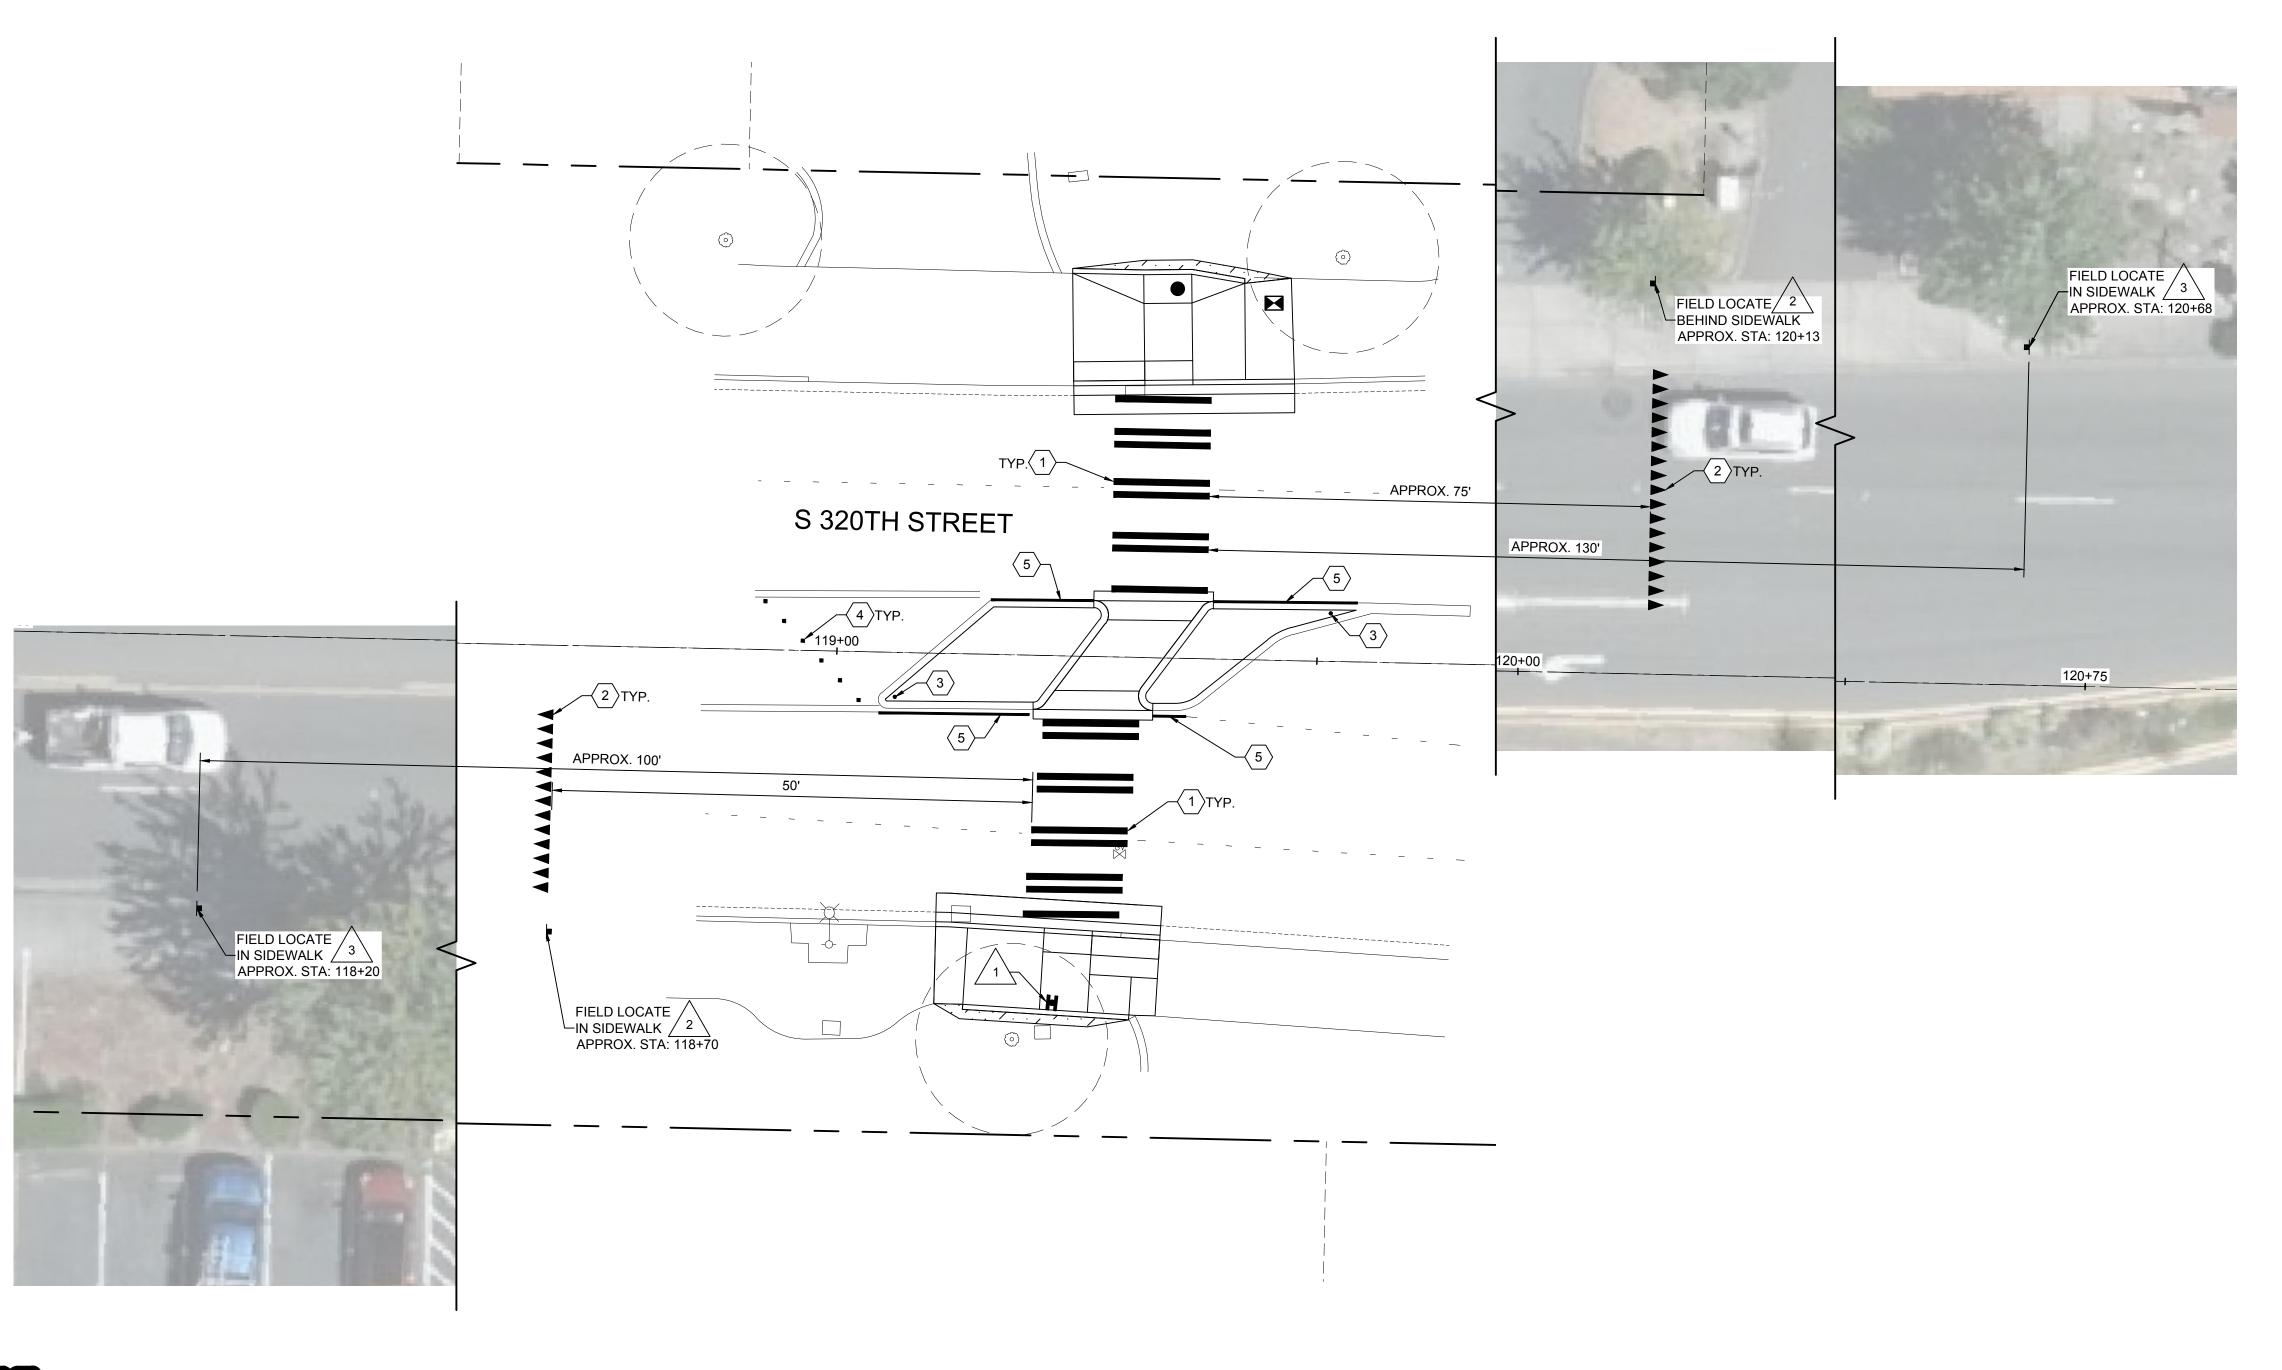
CITYWIDE PEDESTRIAN SAFETY

PAVING AND GRADING PLAN LOCATION 8: SW 356TH ST AT 23RD AVE SW

100% DESIGN

36234

C-208



PAVEMENT MARKING NOTES:

- 1) PLASTIC CROSSWALK LINE PER CITY OF FEDERAL WAY DWG NO
- 2 PLASTIC TYPE 1 YIELD LINE SYMBOLS PER WSDOT STD PLAN M-24.60-04 LOCATED MINIMUM 50' IN ADVANCE OF MARKED CROSSWALK
- (3) 28" TUBULAR MARKER. REFER TO SPECIAL PROVISIONS.
- 4 TYPE 2Y RPM. REFER TO SPECIAL PROVISIONS.
- 5 4" PLASTIC TYPE D EDGE LINE.
- 6 CONVERT REMAINDER OF TWO WAY LEFT TURN LANE TO DOUBLE YELLOW CENTER LINE PER CITY OF FEDERAL WAY DWG NO 3-17.
- 7 4" PLASTIC TYPE D LANE LINE PER CITY OF FEDERAL WAY DWG NO 3-18.

GENERAL SIGNAGE NOTES:

- INSTALL SIGNS IN ACCORDANCE WITH FEDERAL WAY DWG NO 3-17 AND 3-18. SIGNS WITHIN EXISTING SIDEWALK SHALL BE SURFACE MOUNTED.
- 2. EDGE OF SIGN SHALL BE A MINIMUM OF 2' FROM FACE OF CURB AND BOTTOM OF SIGN SHALL BE A MINIMUM OF 7' ABOVE FINISHED GRADE.

SIGNAGE NOTES:

1\RRFB ASSEMBLY. REFER TO RRFB PLANS.

YIELD HERE TO PEDESTRIANS SIGN (R1-5A). ALIGN WITH YIELD LINE SYMBOLS.

PEDESTRIAN SIGN (W11-2). LOCATE MINIMUM 100' IN ADVANCE OF MARKED CROSSWALK.

 $\sqrt{4}$ RELOCATED SR509 NORTH SIGN.

 $^{'5}$ \setminus APPROXIMATE LOCATION OF EXISTING SCHOOL ZONE AHEAD SIGN.

PEDESTRIAN SIGN (W11-2). LOCATE MINIMUM 100' IN ADVANCE OF EXISTING SCHOOL ZONE AHEAD SIGN.

RELOCATE EXISTING SCHOOL ZONE AHEAD SIGN MINIMUM 100' FROM MARKED CROSSWALK AND MINIMUM 100' IN ADVANCE OF SCHOOL ZONE.

8 RELOCATE EXISTING REDUCED SCHOOL SPEED LIMIT AHEAD SIGN MINIMUM 100' IN ADVANCE OF PEDESTRIAN WARNING SIGN.

PEDESTRIAN SIGN (W11-2). LOCATE MINIMUM 100' IN ADVANCE OF MARKED CROSSWALK.


RELOCATE EXISTING SPEED LIMIT SIGN MINIMUM 100' IN ADVANCE OF PROPOSED PEDESTRIAN SIGN.

/11ackslash RELOCATED WELCOME TO FEDERAL WAY SIGNS.

RELOCATE EXISTING SPEED LIMIT SIGN MINIMUM 100' IN ADVANCE OF PEDESTRIAN SIGN.

/13\ INSTALL ON SIDEWALK PER CITY OF TACOMA STANDARD PLAN SU-34.

RELOCATE EXISTING STOP AHEAD SIGN MINIMUM 50' AFTER MARKED CROSSWALK.

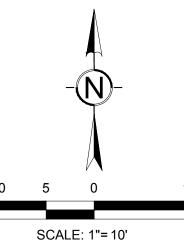

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TACOMA, WA 98402

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DRAFTED: RJB

DESIGNED: MB/SMP

REVIEWED: JBD

APPROVED:

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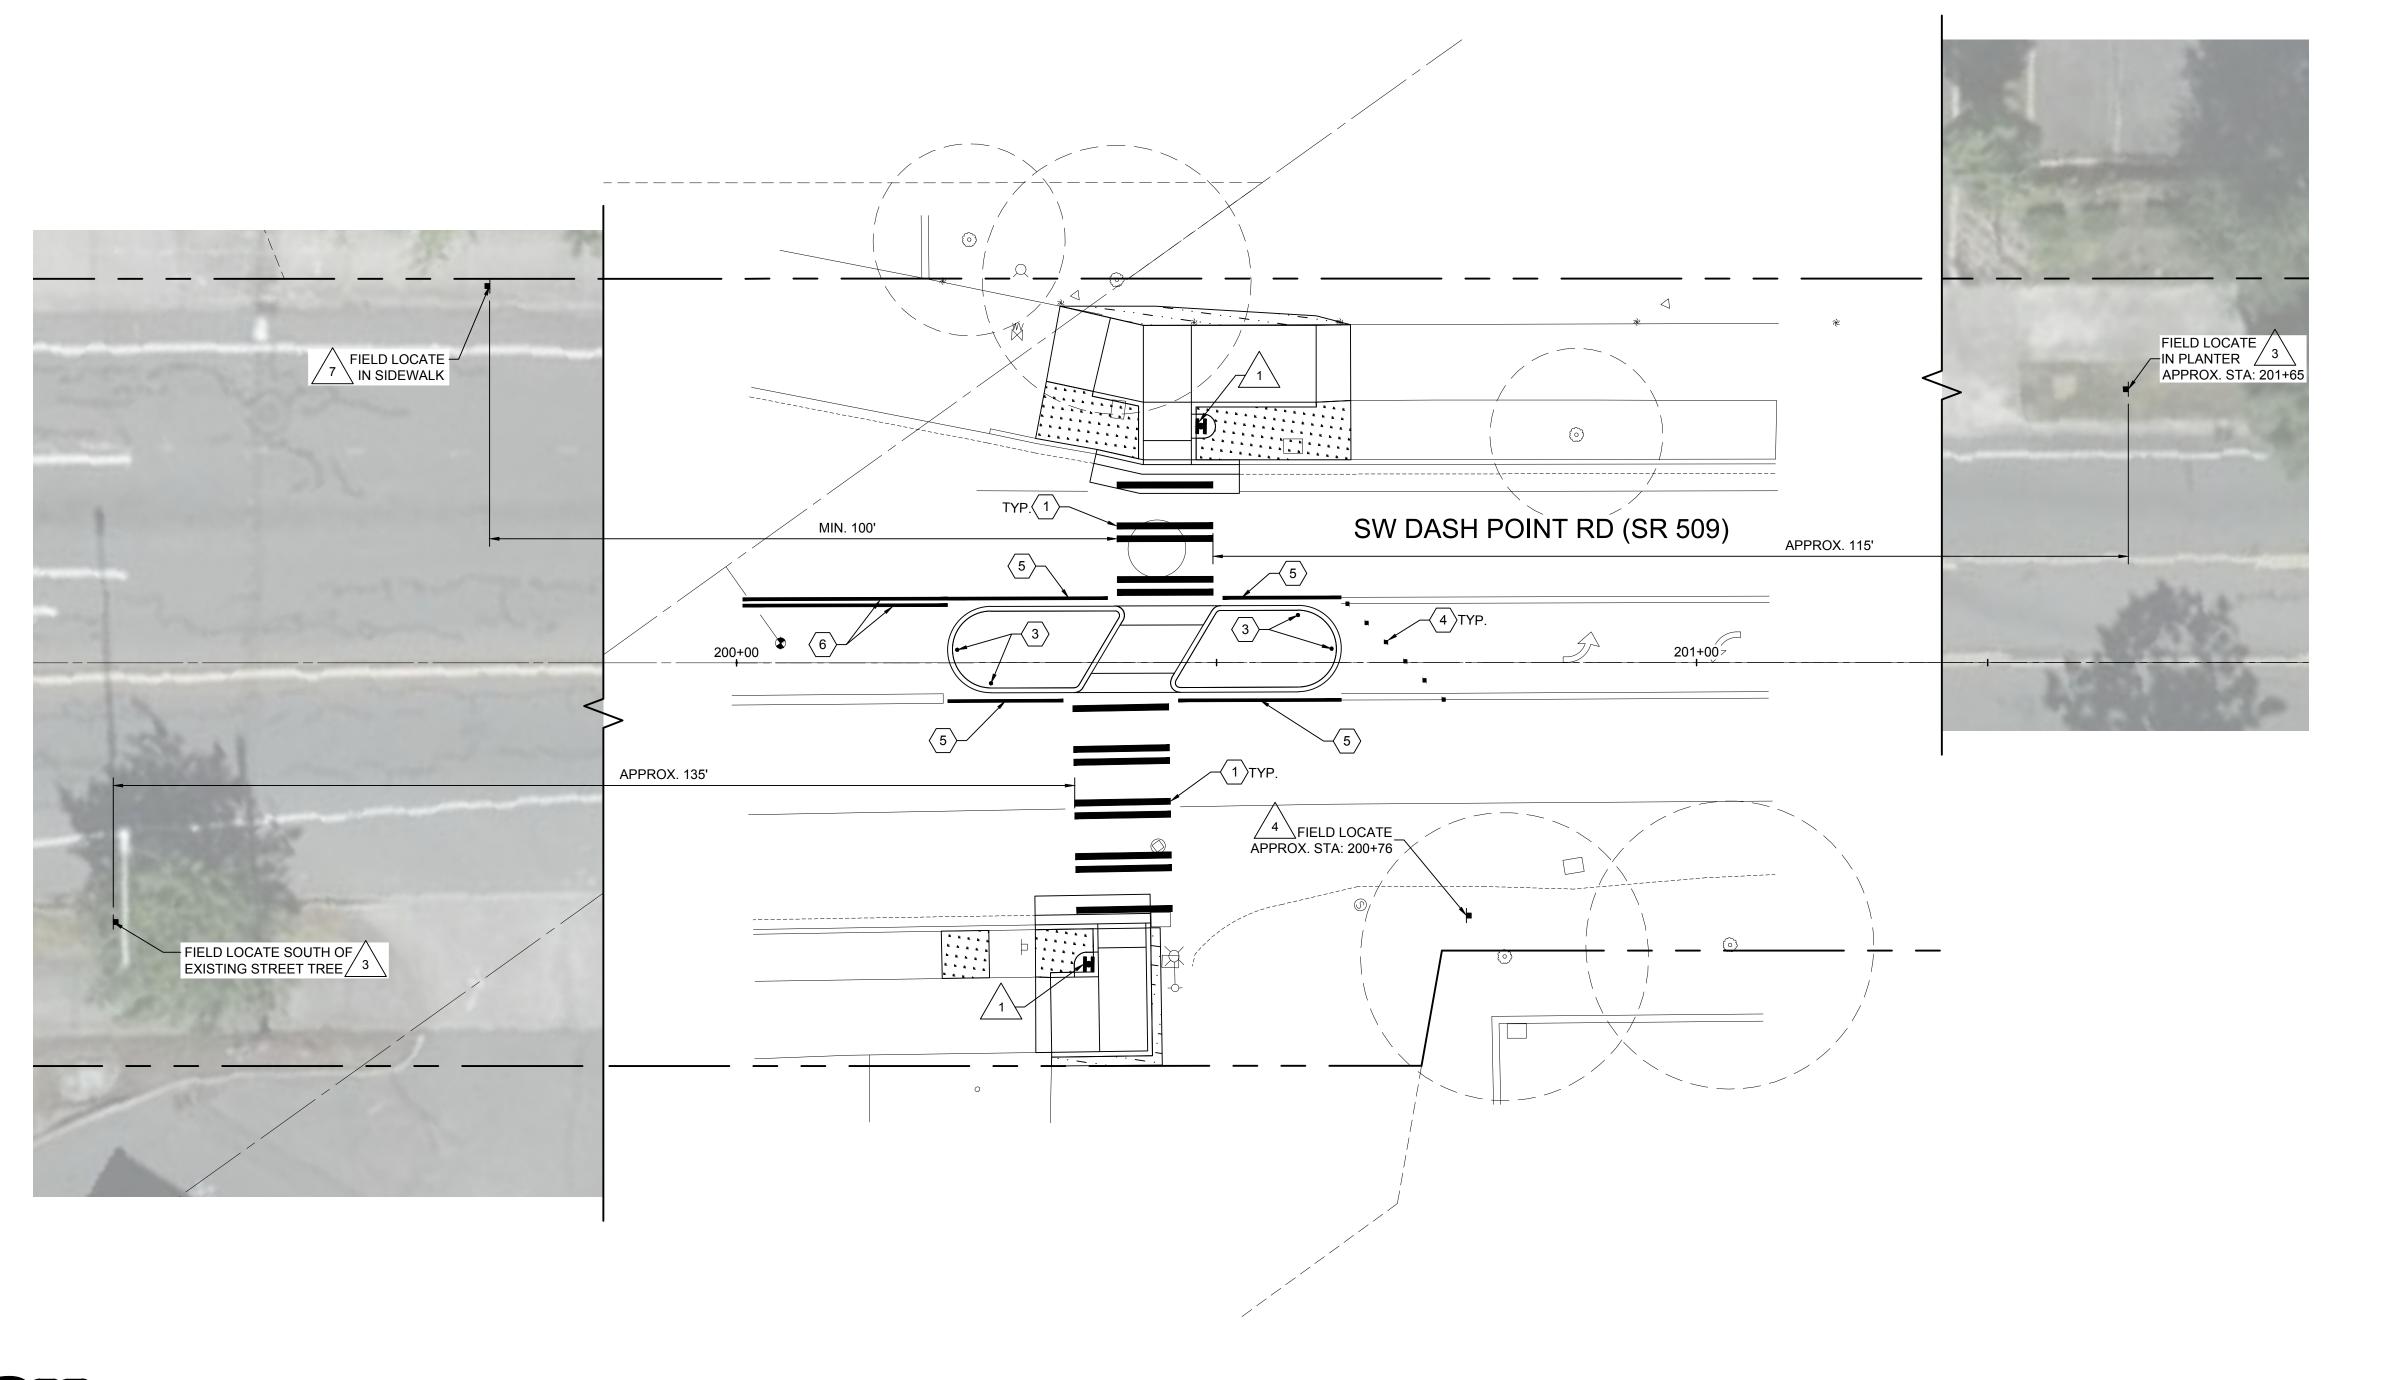
CITYWIDE PEDESTRIAN SAFETY

PAVEMENT MARKING AND SIGNAGE PLAN LOCATION 1: S 320TH ST - 1400 BLOCK

100% DESIGN

CITY PROJECT #

C-301



PAVEMENT MARKING NOTES:

- 1 PLASTIC CROSSWALK LINE PER CITY OF FEDERAL WAY DWG NO
- 2 PLASTIC TYPE 1 YIELD LINE SYMBOLS PER WSDOT STD PLAN M-24.60-04 LOCATED MINIMUM 50' IN ADVANCE OF MARKED
- (3) 28" TUBULAR MARKER. REFER TO SPECIAL PROVISIONS.
- 4 TYPE 2Y RPM. REFER TO SPECIAL PROVISIONS.
- 5 4" PLASTIC TYPE D EDGE LINE.
- 6 CONVERT REMAINDER OF TWO WAY LEFT TURN LANE TO DOUBLE YELLOW CENTER LINE PER CITY OF FEDERAL WAY DWG NO 3-17.
- (7) 4" PLASTIC TYPE D LANE LINE PER CITY OF FEDERAL WAY DWG NO

GENERAL SIGNAGE NOTES:

- INSTALL SIGNS IN ACCORDANCE WITH FEDERAL WAY DWG NO 3-17 AND 3-18. SIGNS WITHIN EXISTING SIDEWALK SHALL BE SURFACE MOUNTED.
- 2. EDGE OF SIGN SHALL BE A MINIMUM OF 2' FROM FACE OF CURB AND BOTTOM OF SIGN SHALL BE A MINIMUM OF 7' ABOVE FINISHED GRADE.

SIGNAGE NOTES:

 $^{\prime}_{1}ackslash$ RRFB ASSEMBLY. REFER TO RRFB PLANS.

 $^{\prime}$ 2 $^{\setminus}$ YIELD HERE TO PEDESTRIANS SIGN (R1-5A). ALIGN WITH YIELD LINE

PEDESTRIAN SIGN (W11-2). LOCATE MINIMUM 100' IN ADVANCE OF MARKED CROSSWALK.

 $^{/}$ 4 $^{\setminus}$ RELOCATED SR509 NORTH SIGN.

 $^{'}$ 5 \setminus APPROXIMATE LOCATION OF EXISTING SCHOOL ZONE AHEAD SIGN.

6 \ PEDESTRIAN SIGN (W11-2). LOCATE MINIMUM 100' IN ADVANCE OF EXISTING SCHOOL ZONE ÁHEAD SIGN.

RELOCATE EXISTING SCHOOL ZONE AHEAD SIGN MINIMUM 100' FROM MARKED CROSSWALK AND MINIMUM 100' IN ADVANCE OF SCHOOL ZONE.

8 RELOCATE EXISTING REDUCED SCHOOL SPEED LIMIT AHEAD SIGN ¹MINIMUM 100' IN ADVANCE OF PEDESTRIAN WARNING SIGN.

 $\sqrt{9}$ PEDESTRIAN SIGN (W11-2). LOCATE MINIMUM 100' IN ADVANCE OF MARKED CROSSWALK.


10 RELOCATE EXISTING SPEED LIMIT SIGN MINIMUM 100' IN ADVANCE OF PROPOSED PEDESTRIAN SIGN.

/11ackslash RELOCATED WELCOME TO FEDERAL WAY SIGNS.

 $^{\prime}$ 12 \setminus RELOCATE EXISTING SPEED LIMIT SIGN MINIMUM 100' IN ADVANCE OF PEDESTRIAN SIGN.

/13\ INSTALL ON SIDEWALK PER CITY OF TACOMA STANDARD PLAN

14\ RELOCATE EXISTING STOP AHEAD SIGN MINIMUM 50' AFTER MARKED CROSSWALK.

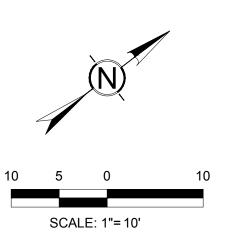



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CITYWIDE PEDESTRIAN SAFETY

100% DESIGN CITY PROJECT # 36234

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DRAFTED: RJB

DESIGNED: MB/SMP

REVIEWED: JBD


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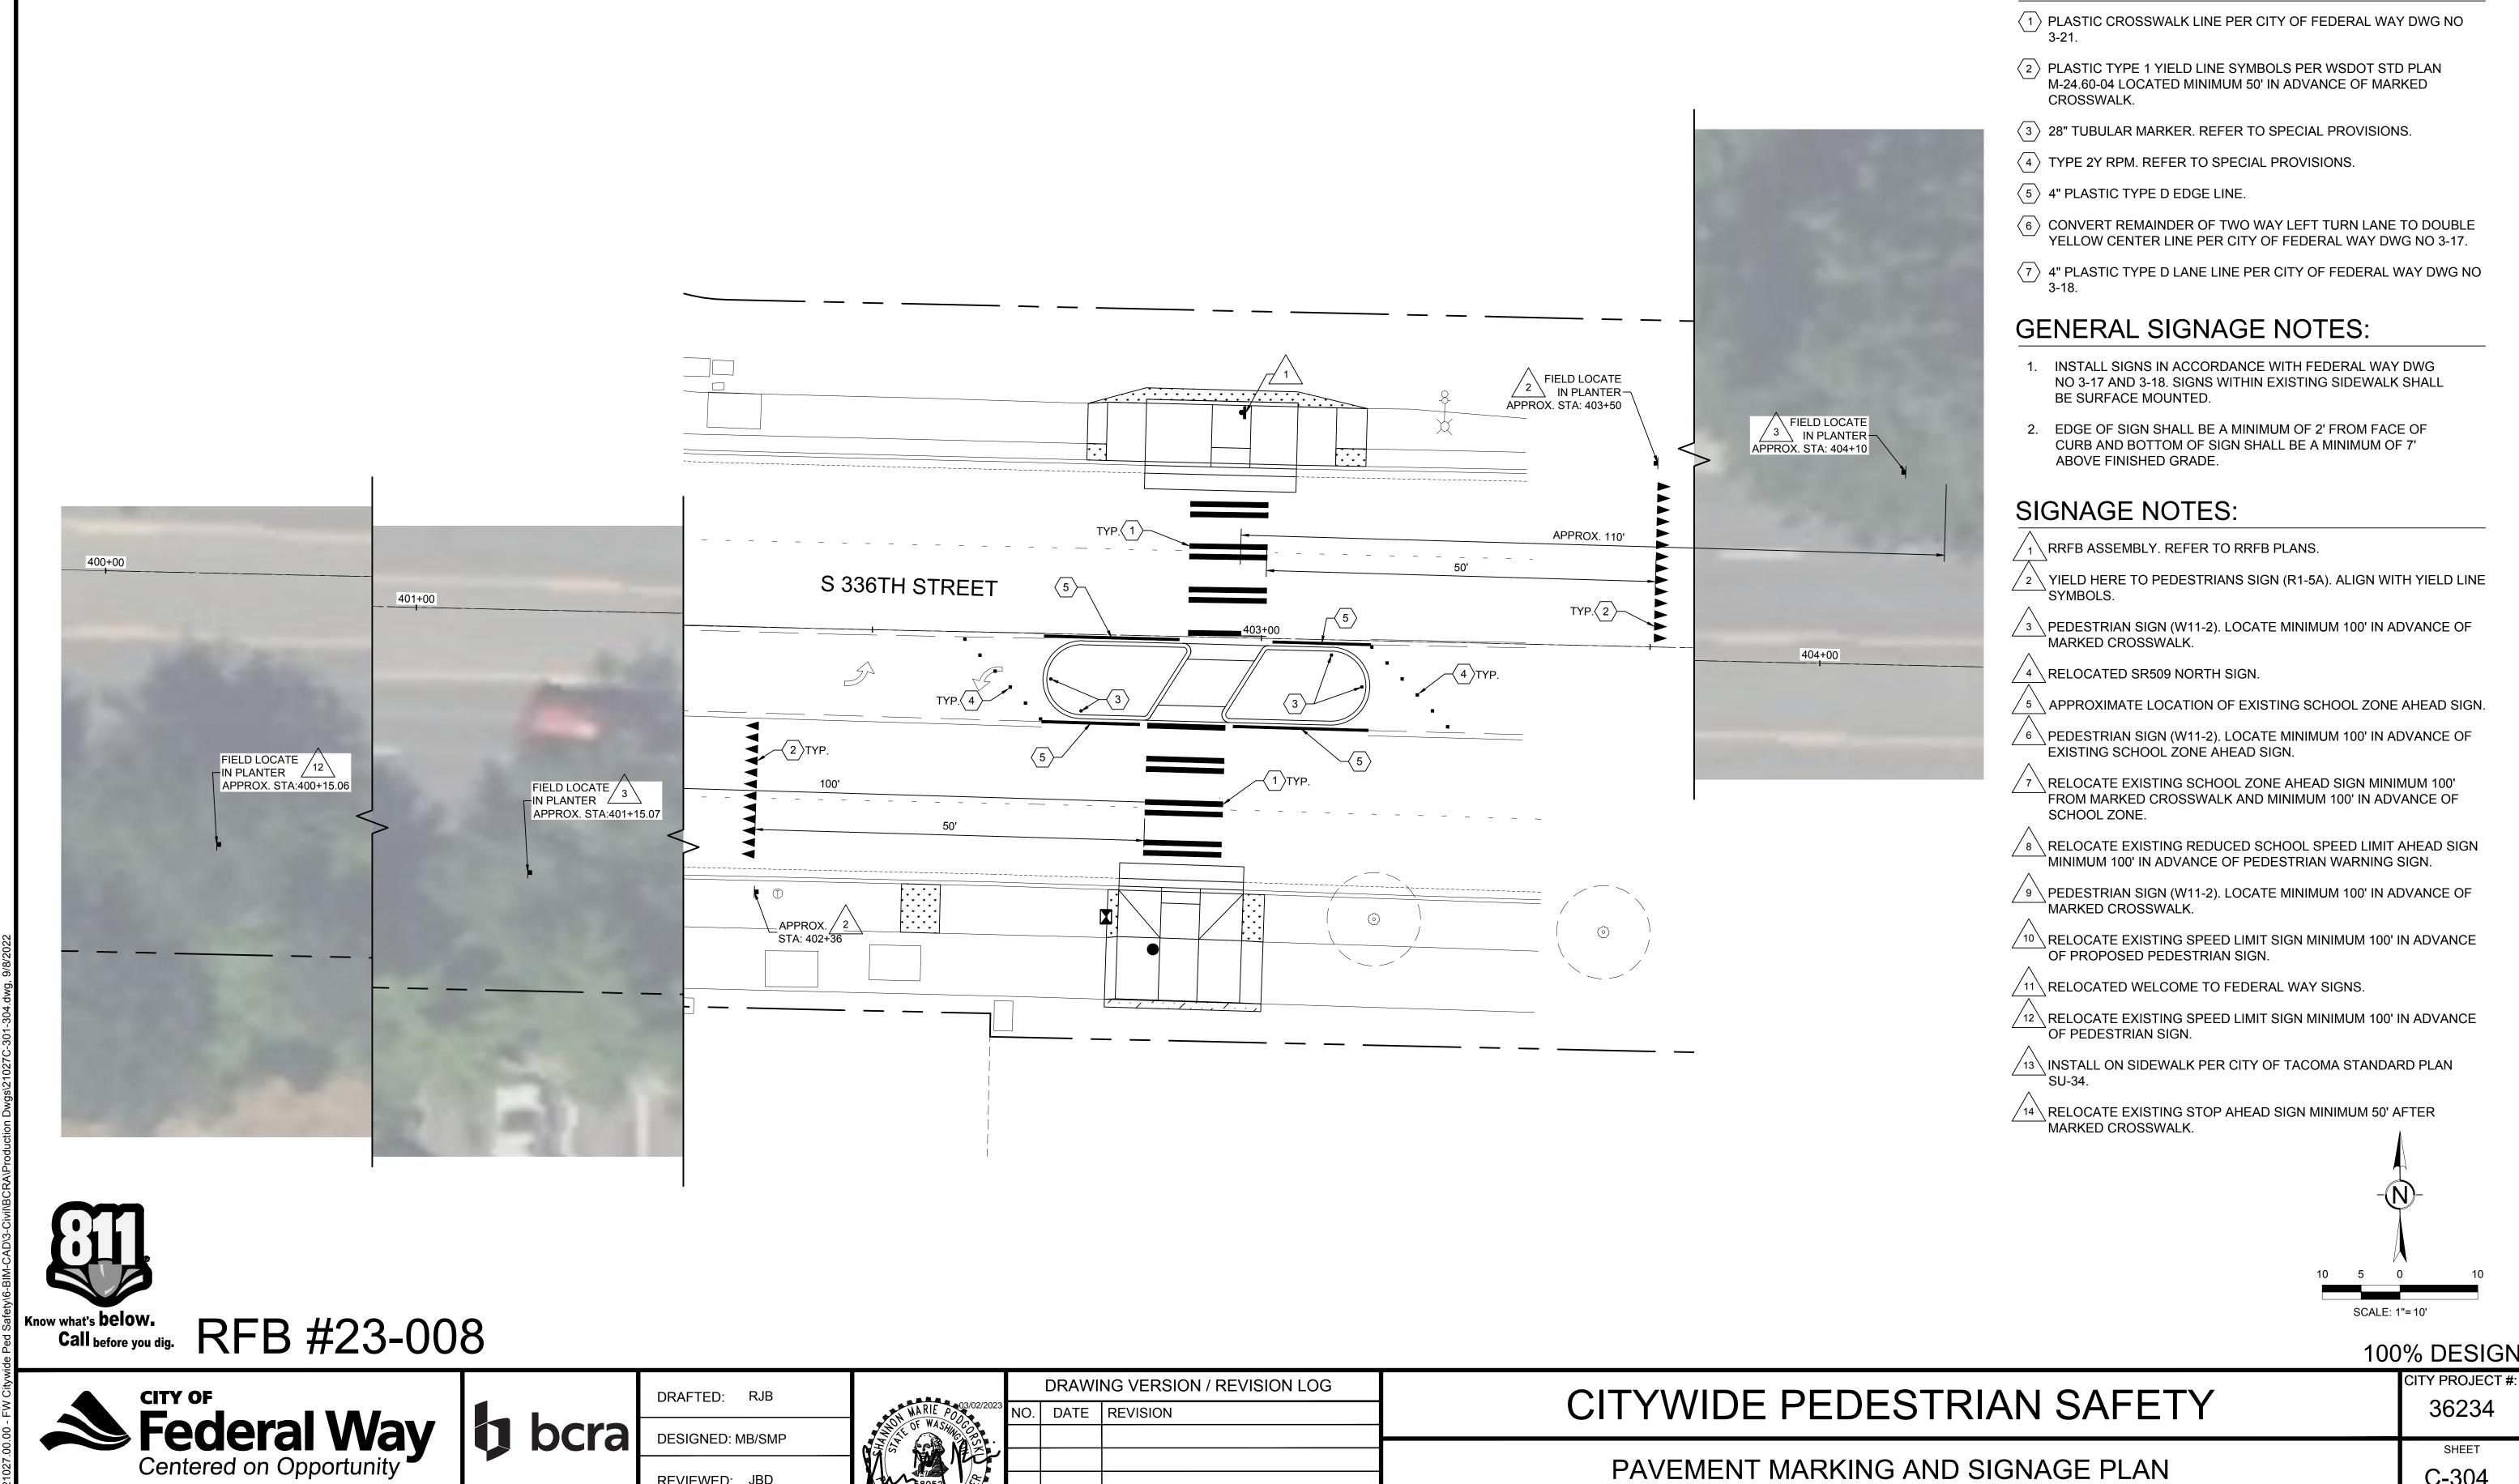
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PAVEMENT MARKING AND SIGNAGE PLAN LOCATION 2: SR 509 SOUTH OF 16TH AVE SW

SHEET C-302





REVIEWED: JBD

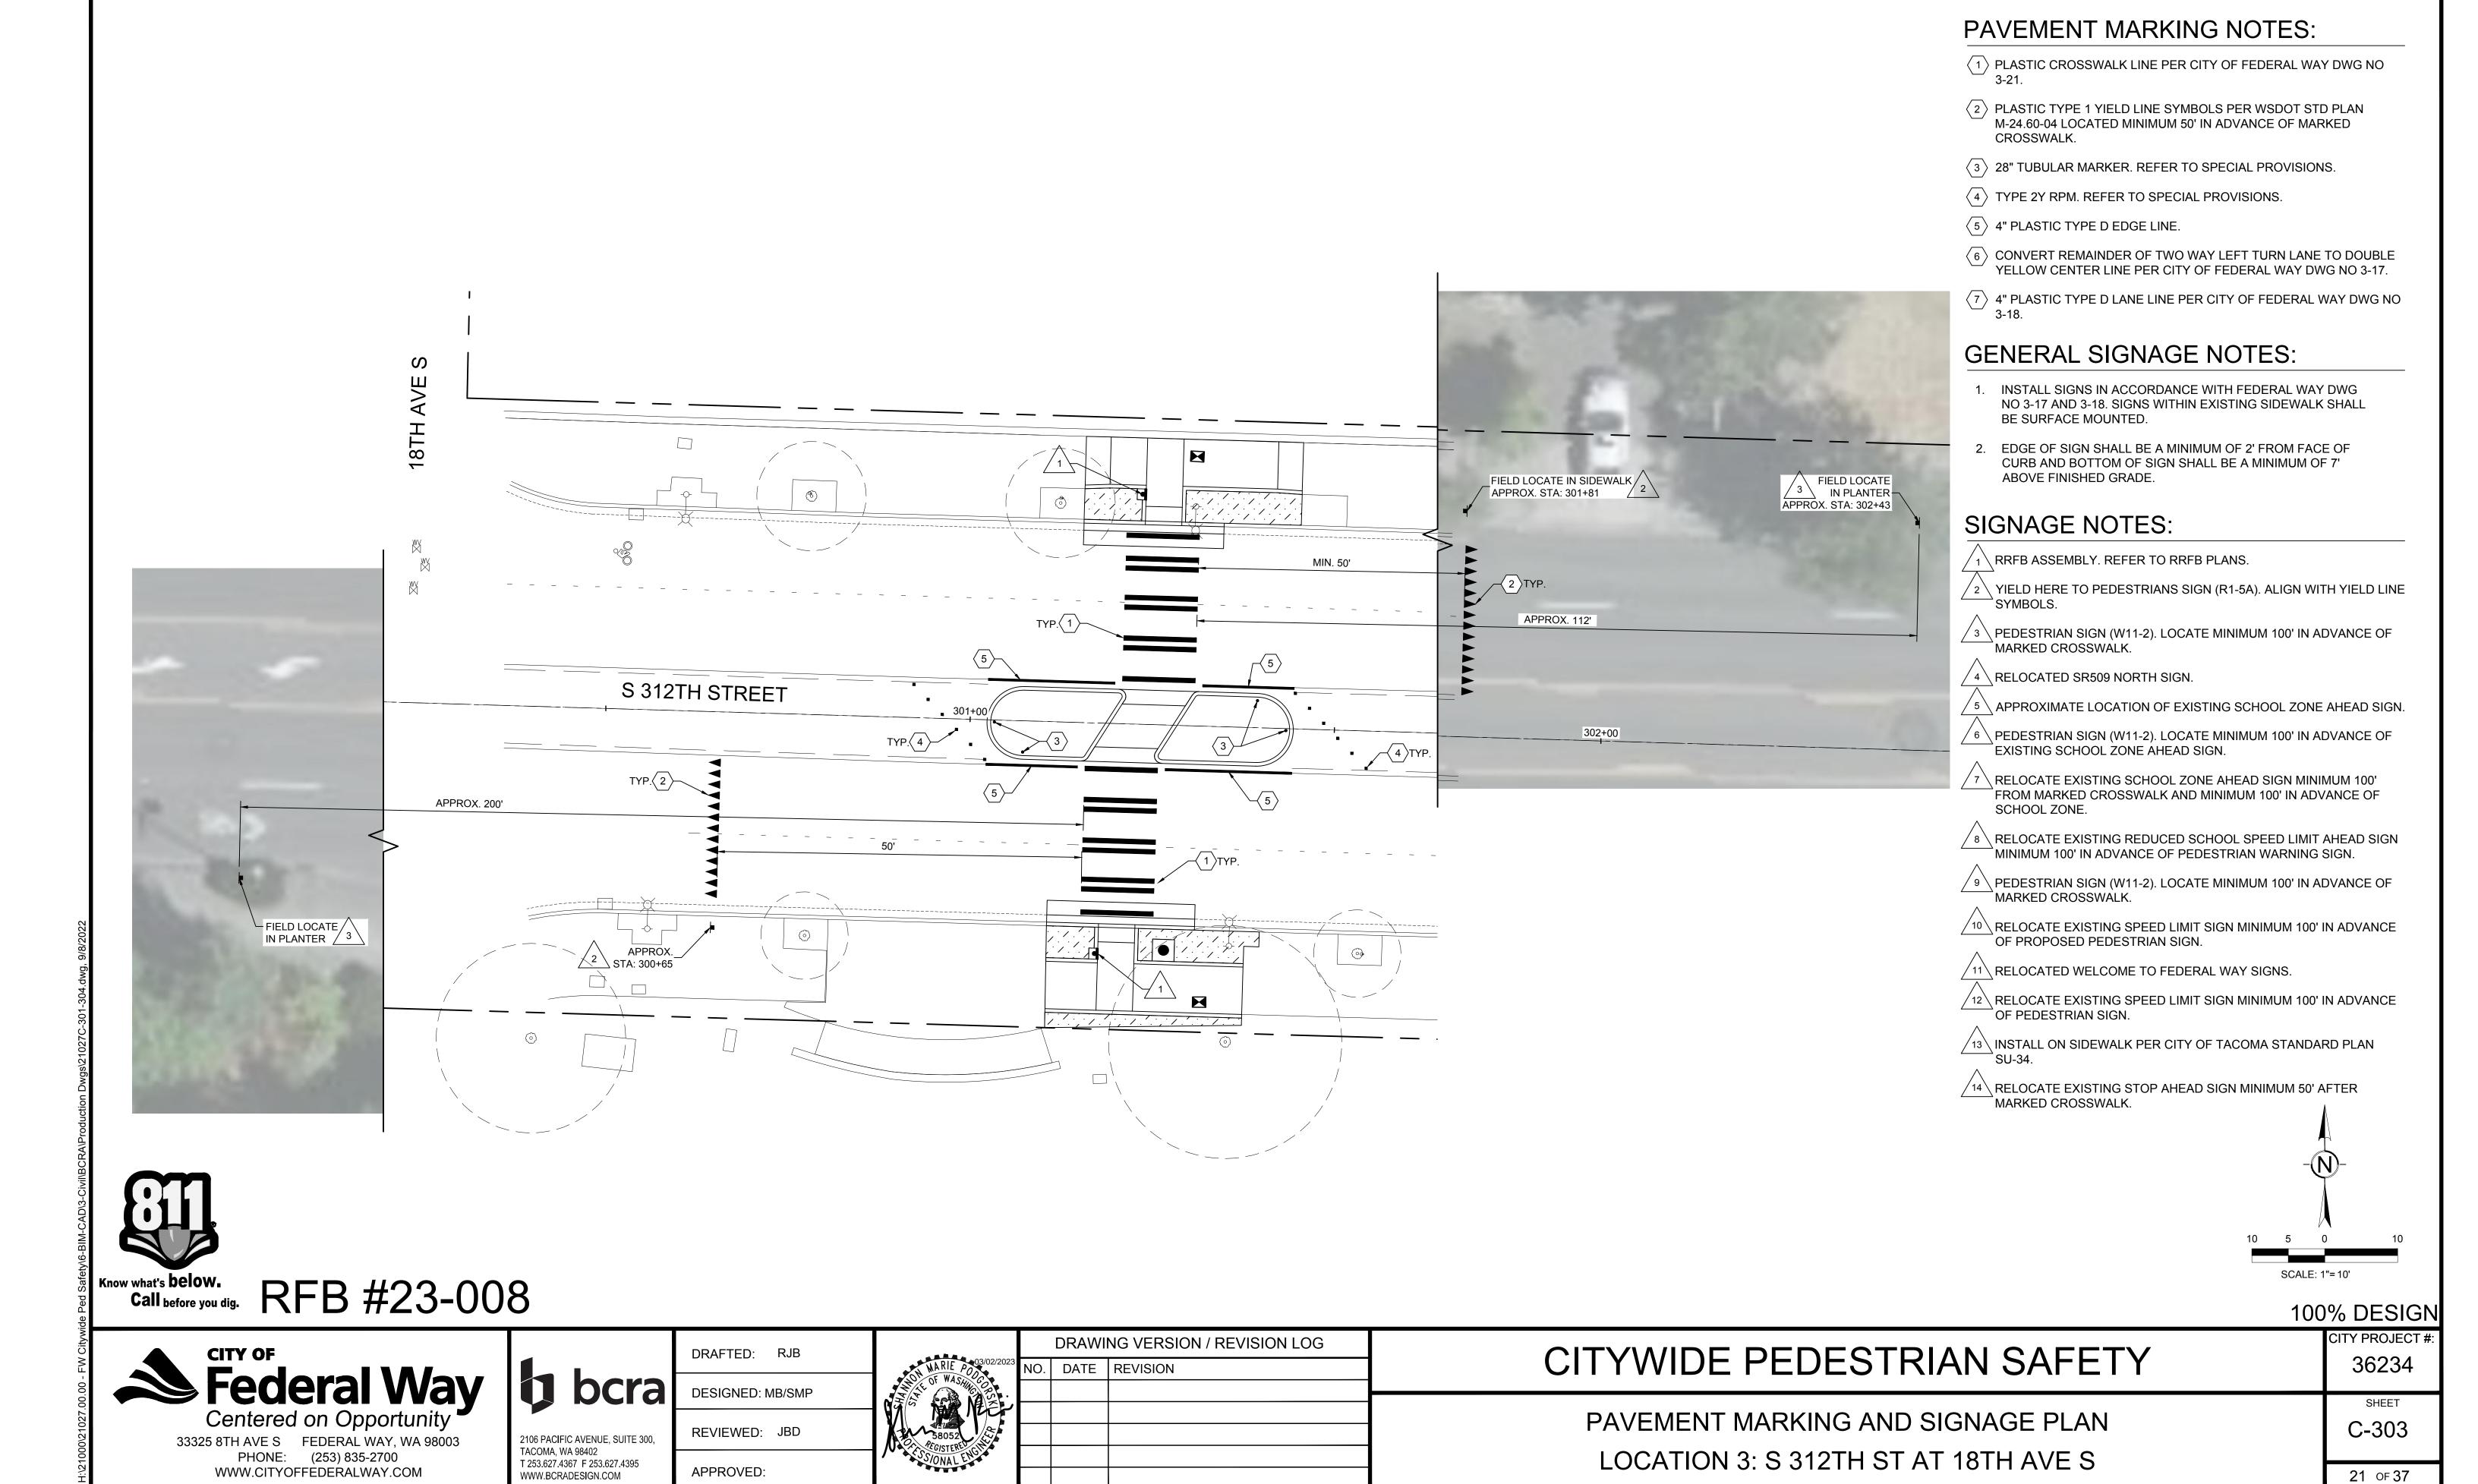APPROVED:

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PAVEMENT MARKING NOTES:

SHEET

C-304

22 OF 37


PAVEMENT MARKING AND SIGNAGE PLAN

LOCATION 4: S 336TH ST AT 10TH PL S

33325 8TH AVE S FEDERAL WAY, WA 98003

PHONE: (253) 835-2700

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PAVEMENT MARKING NOTES:

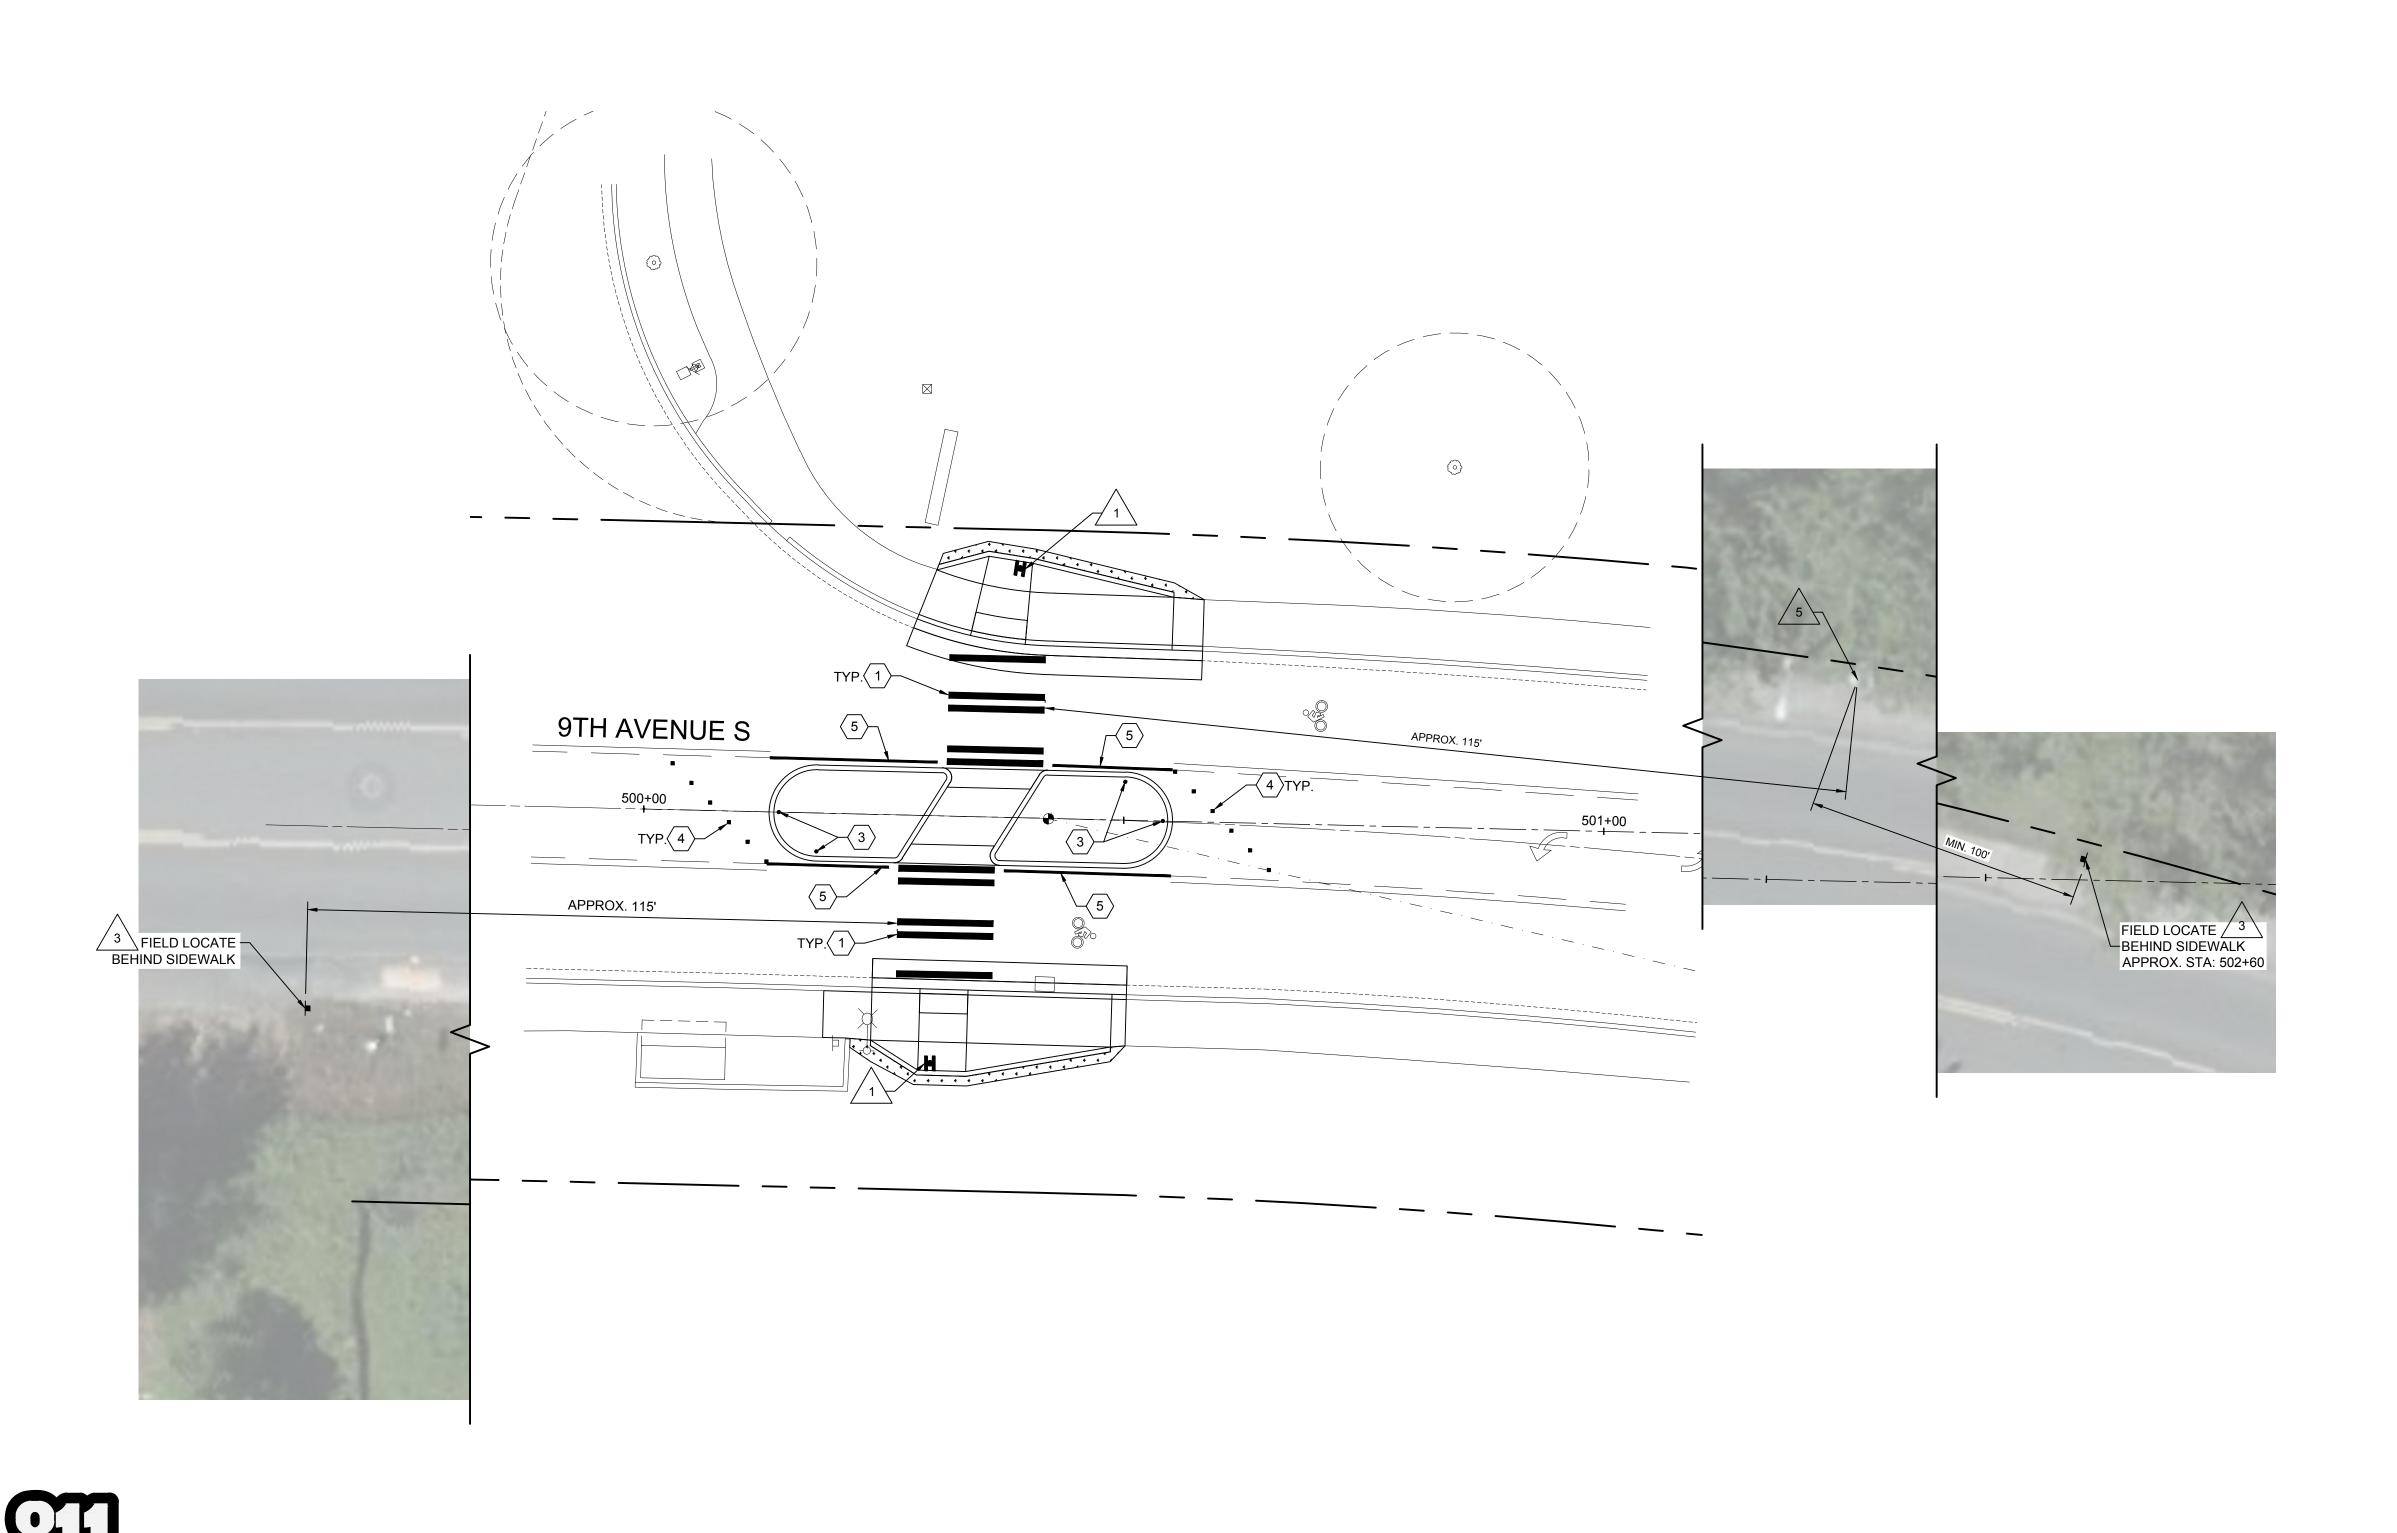- 1 PLASTIC CROSSWALK LINE PER CITY OF FEDERAL WAY DWG NO
- $\langle 2 \rangle$ PLASTIC TYPE 1 YIELD LINE SYMBOLS PER WSDOT STD PLAN M-24.60-04 LOCATED MINIMUM 50' IN ADVANCE OF MARKED
- (3) 28" TUBULAR MARKER. REFER TO SPECIAL PROVISIONS.
- 4 TYPE 2Y RPM. REFER TO SPECIAL PROVISIONS.
- 5 4" PLASTIC TYPE D EDGE LINE.
- 6 CONVERT REMAINDER OF TWO WAY LEFT TURN LANE TO DOUBLE YELLOW CENTER LINE PER CITY OF FEDERAL WAY DWG NO 3-17.
- (7) 4" PLASTIC TYPE D LANE LINE PER CITY OF FEDERAL WAY DWG NO

GENERAL SIGNAGE NOTES:

- 1. INSTALL SIGNS IN ACCORDANCE WITH FEDERAL WAY DWG NO 3-17 AND 3-18. SIGNS WITHIN EXISTING SIDEWALK SHALL BE SURFACE MOUNTED.
- 2. EDGE OF SIGN SHALL BE A MINIMUM OF 2' FROM FACE OF CURB AND BOTTOM OF SIGN SHALL BE A MINIMUM OF 7' ABOVE FINISHED GRADE.

SIGNAGE NOTES:

1 \ RRFB ASSEMBLY. REFER TO RRFB PLANS.

² YIELD HERE TO PEDESTRIANS SIGN (R1-5A). ALIGN WITH YIELD LINE

/3\PEDESTRIAN SIGN (W11-2). LOCATE MINIMUM 100' IN ADVANCE OF MARKED CROSSWALK.

 $^{\prime}$ 4 $^{\setminus}$ RELOCATED SR509 NORTH SIGN.

5 \ APPROXIMATE LOCATION OF EXISTING SCHOOL ZONE AHEAD SIGN.

 $^{\prime}$ 6 $^{\prime}$ PEDESTRIAN SIGN (W11-2). LOCATE MINIMUM 100' IN ADVANCE OF EXISTING SCHOOL ZONE AHEAD SIGN.

RELOCATE EXISTING SCHOOL ZONE AHEAD SIGN MINIMUM 100' FROM MARKED CROSSWALK AND MINIMUM 100' IN ADVANCE OF SCHOOL ZONE.

8 RELOCATE EXISTING REDUCED SCHOOL SPEED LIMIT AHEAD SIGN MINIMUM 100' IN ADVANCE OF PEDESTRIAN WARNING SIGN.

9 PEDESTRIAN SIGN (W11-2). LOCATE MINIMUM 100' IN ADVANCE OF MARKED CROSSWALK.


 $^{\prime}$ 10 \setminus RELOCATE EXISTING SPEED LIMIT SIGN MINIMUM 100' IN ADVANCE OF PROPOSED PEDESTRIAN SIGN.

/ 11ackslash RELOCATED WELCOME TO FEDERAL WAY SIGNS.

12\ RELOCATE EXISTING SPEED LIMIT SIGN MINIMUM 100' IN ADVANCE OF PEDESTRIAN SIGN.

/13\ INSTALL ON SIDEWALK PER CITY OF TACOMA STANDARD PLAN

14 RELOCATE EXISTING STOP AHEAD SIGN MINIMUM 50' AFTER MARKED CROSSWALK.

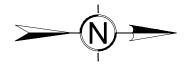

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DESIGNED: MB/SMP

REVIEWED: JBD


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CITYWIDE PEDESTRIAN SAFETY

PAVEMENT MARKING AND SIGNAGE PLAN LOCATION 5: 9TH AVE S AT ST. FRANCIS HOSPITAL CITY PROJECT # 36234

> SHEET C-305



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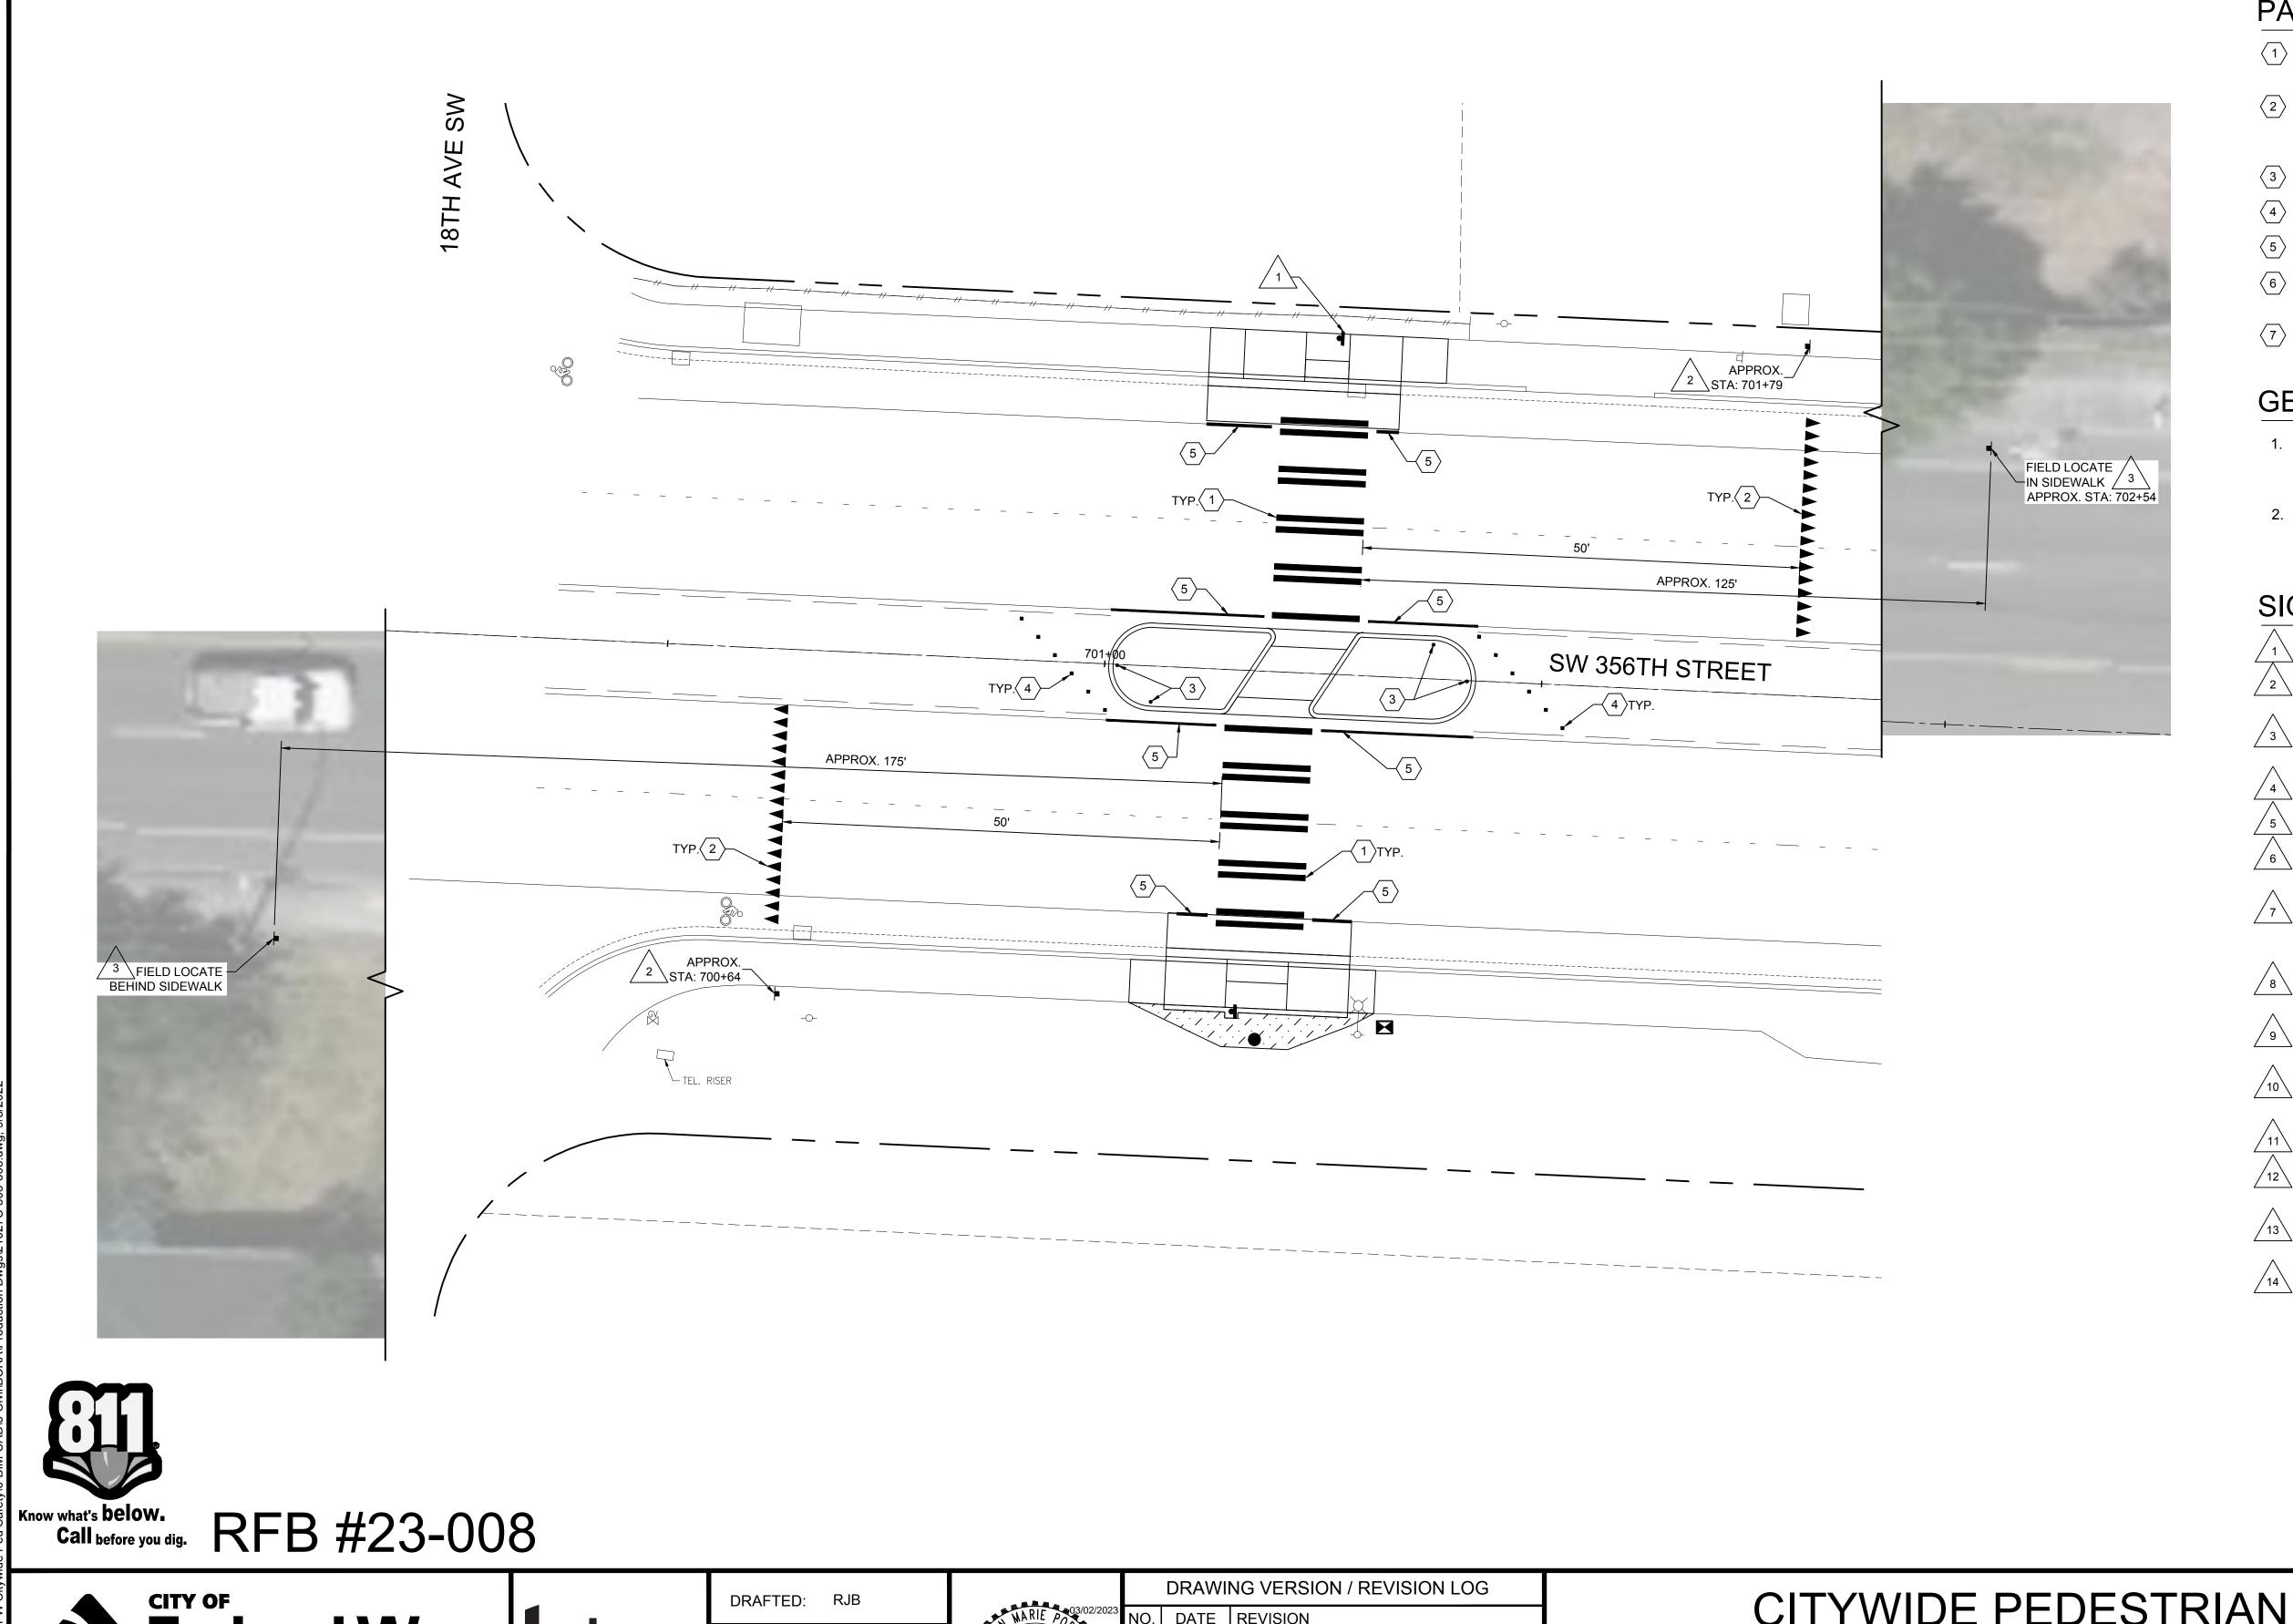
CITYWIDE PEDESTRIAN SAFETY

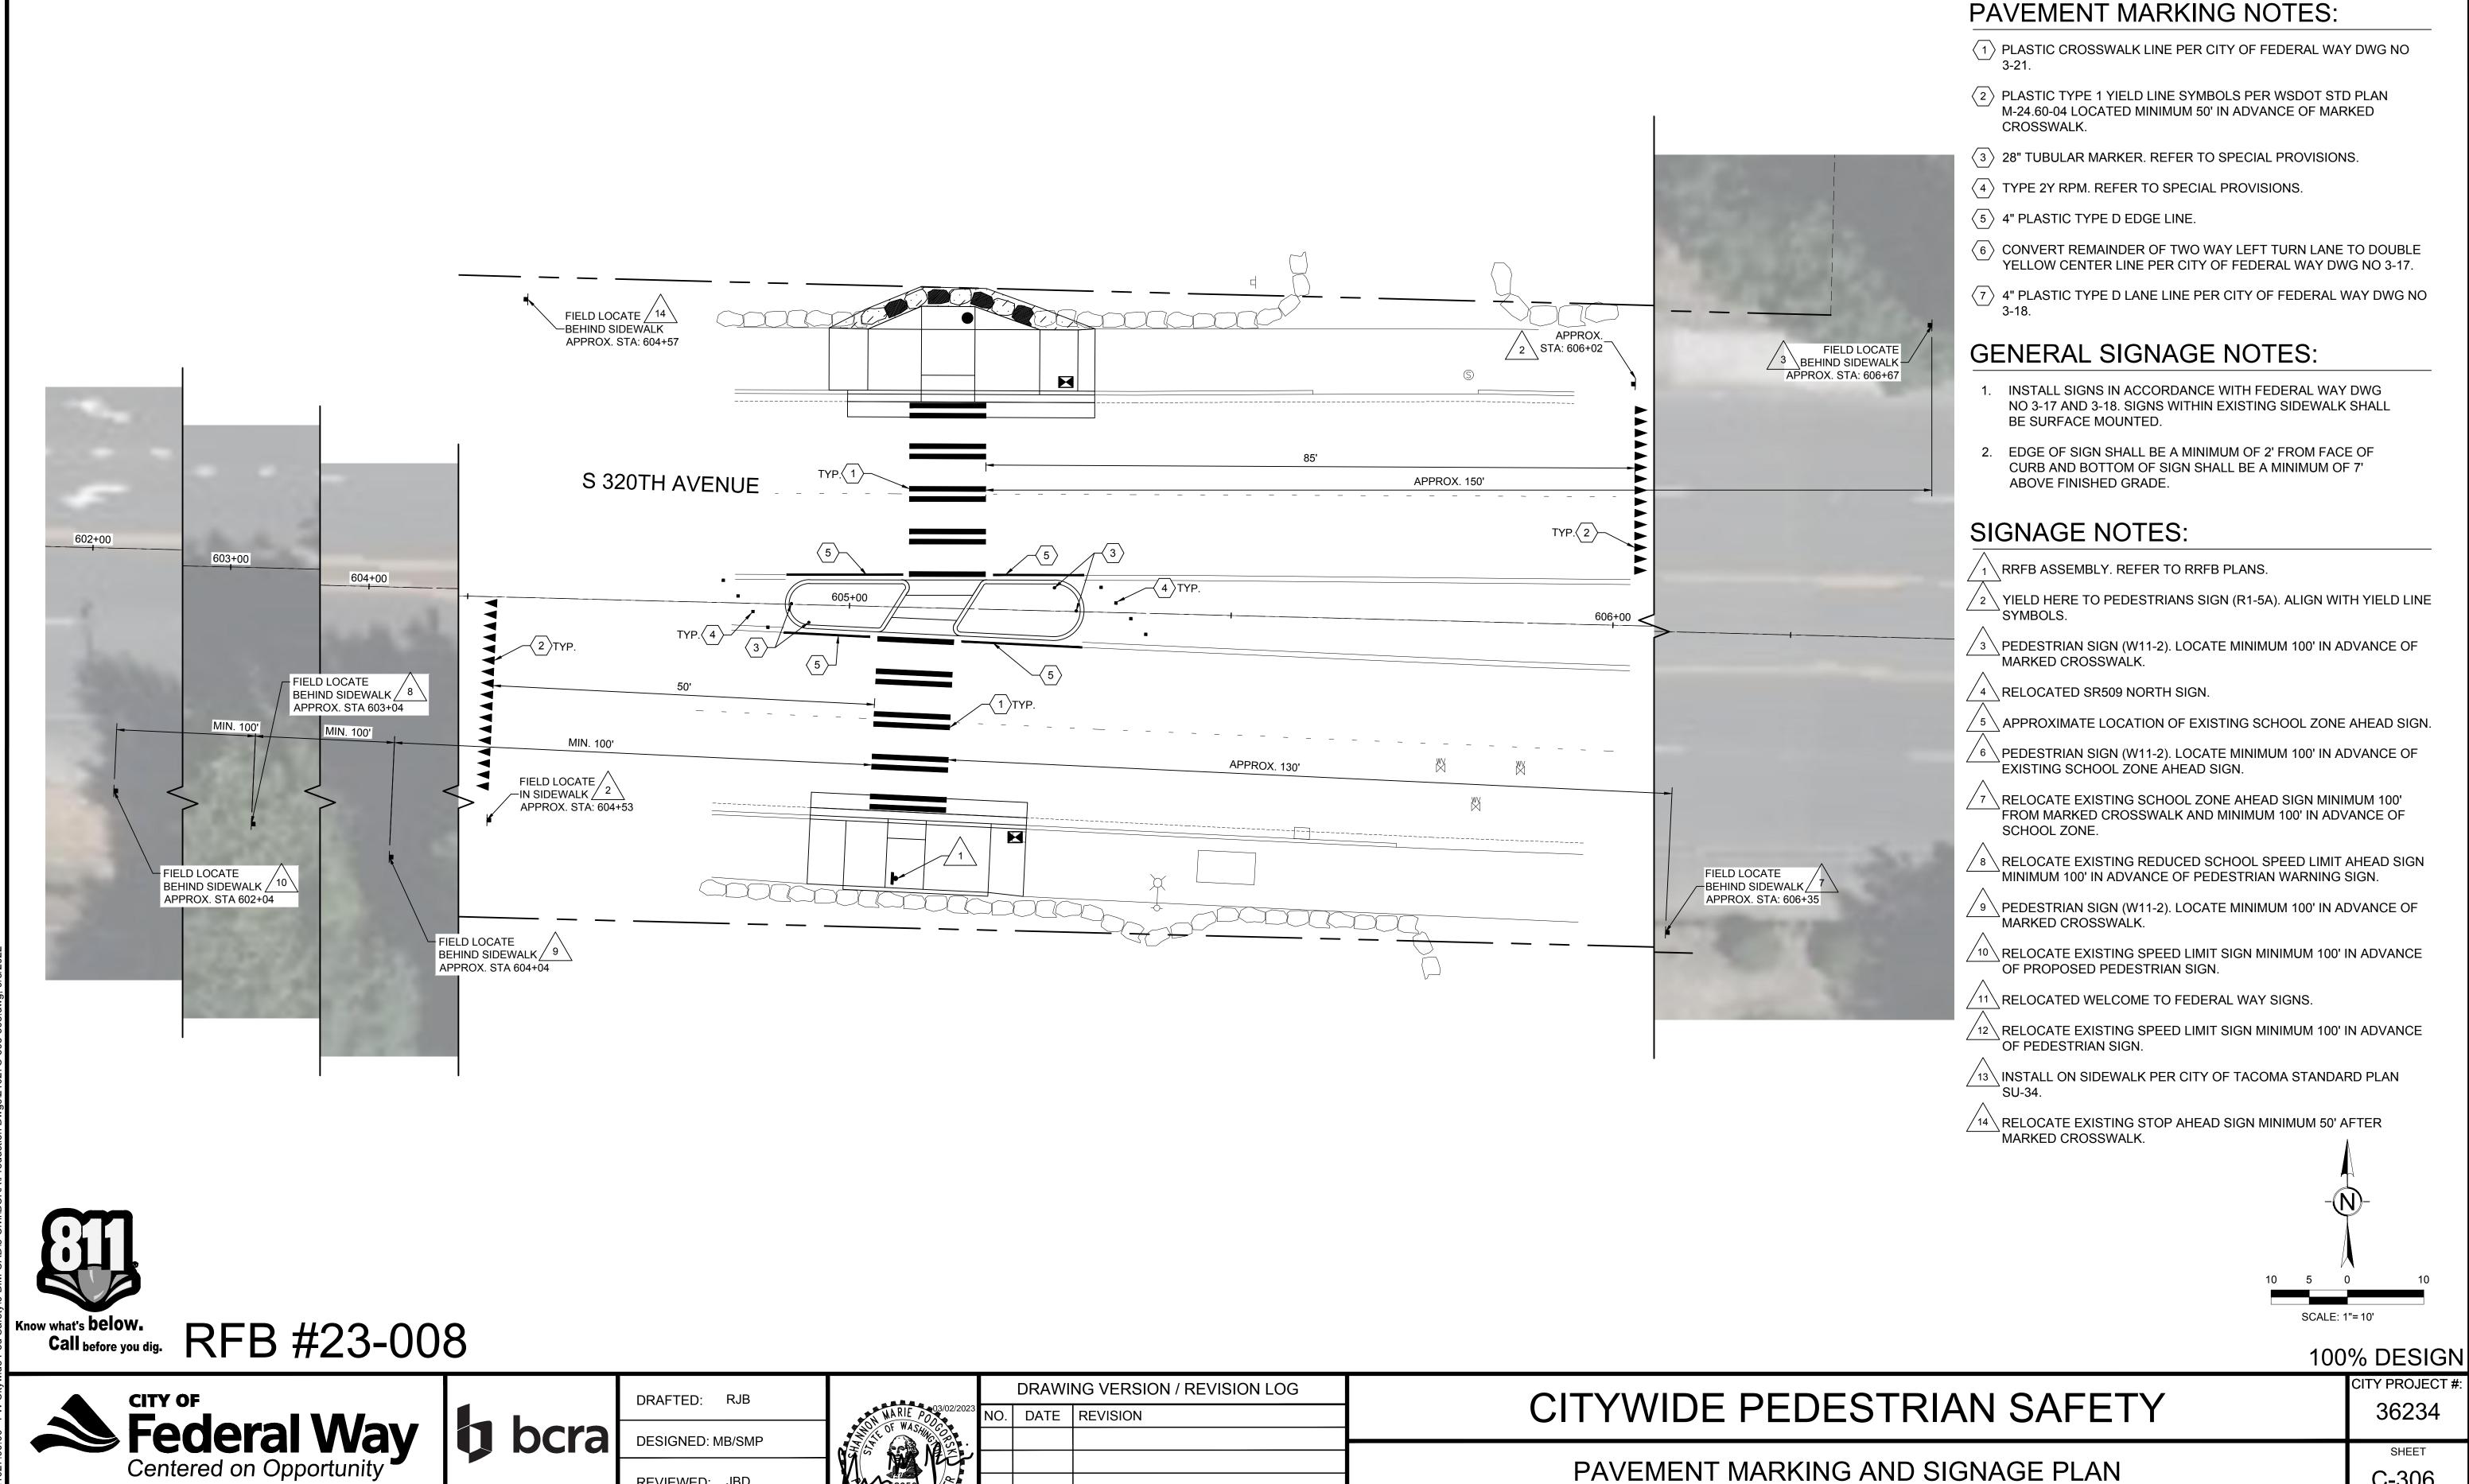PAVEMENT MARKING AND SIGNAGE PLAN LOCATION 6: SW 320TH ST AT 45TH PL SW CITY PROJECT #

SHEET

C-306

24 OF 37



PAVEMENT MARKING NOTES:

1 PLASTIC CROSSWALK LINE PER CITY OF FEDERAL WAY DWG NO

 $\langle 2 \rangle$ PLASTIC TYPE 1 YIELD LINE SYMBOLS PER WSDOT STD PLAN M-24.60-04 LOCATED MINIMUM 50' IN ADVANCE OF MARKED

(3) 28" TUBULAR MARKER. REFER TO SPECIAL PROVISIONS.

4 TYPE 2Y RPM. REFER TO SPECIAL PROVISIONS.

5 4" PLASTIC TYPE D EDGE LINE.

6 CONVERT REMAINDER OF TWO WAY LEFT TURN LANE TO DOUBLE YELLOW CENTER LINE PER CITY OF FEDERAL WAY DWG NO 3-17.

(7) 4" PLASTIC TYPE D LANE LINE PER CITY OF FEDERAL WAY DWG NO

GENERAL SIGNAGE NOTES:

1. INSTALL SIGNS IN ACCORDANCE WITH FEDERAL WAY DWG NO 3-17 AND 3-18. SIGNS WITHIN EXISTING SIDEWALK SHALL BE SURFACE MOUNTED.

2. EDGE OF SIGN SHALL BE A MINIMUM OF 2' FROM FACE OF CURB AND BOTTOM OF SIGN SHALL BE A MINIMUM OF 7' ABOVE FINISHED GRADE.

SIGNAGE NOTES:

1\RRFB ASSEMBLY. REFER TO RRFB PLANS.

 $^{\prime}$ 2 \setminus YIELD HERE TO PEDESTRIANS SIGN (R1-5A). ALIGN WITH YIELD LINE

√3 \ PEDESTRIAN SIGN (W11-2). LOCATE MINIMUM 100' IN ADVANCE OF MARKED CROSSWALK.

 $^{\prime}$ 4 RELOCATED SR509 NORTH SIGN.

 $^{'5}ackslash$ APPROXIMATE LOCATION OF EXISTING SCHOOL ZONE AHEAD SIGN.

6 PEDESTRIAN SIGN (W11-2). LOCATE MINIMUM 100' IN ADVANCE OF EXISTING SCHOOL ZONE AHEAD SIGN.

RELOCATE EXISTING SCHOOL ZONE AHEAD SIGN MINIMUM 100' FROM MARKED CROSSWALK AND MINIMUM 100' IN ADVANCE OF SCHOOL ZONE.

8 RELOCATE EXISTING REDUCED SCHOOL SPEED LIMIT AHEAD SIGN MINIMUM 100' IN ADVANCE OF PEDESTRIAN WARNING SIGN.

9 PEDESTRIAN SIGN (W11-2). LOCATE MINIMUM 100' IN ADVANCE OF MARKED CROSSWALK.


/ 10 RELOCATE EXISTING SPEED LIMIT SIGN MINIMUM 100' IN ADVANCE OF PROPOSED PEDESTRIAN SIGN.

/11ackslash RELOCATED WELCOME TO FEDERAL WAY SIGNS.

 $^{\prime}$ 12ackslash RELOCATE EXISTING SPEED LIMIT SIGN MINIMUM 100' IN ADVANCE OF PEDESTRIAN SIGN.

/13ackslash INSTALL ON SIDEWALK PER CITY OF TACOMA STANDARD PLAN

14 RELOCATE EXISTING STOP AHEAD SIGN MINIMUM 50' AFTER MARKED CROSSWALK.

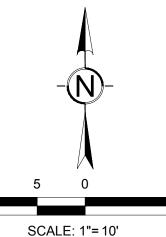

Federal Way
Centered on Opportunity

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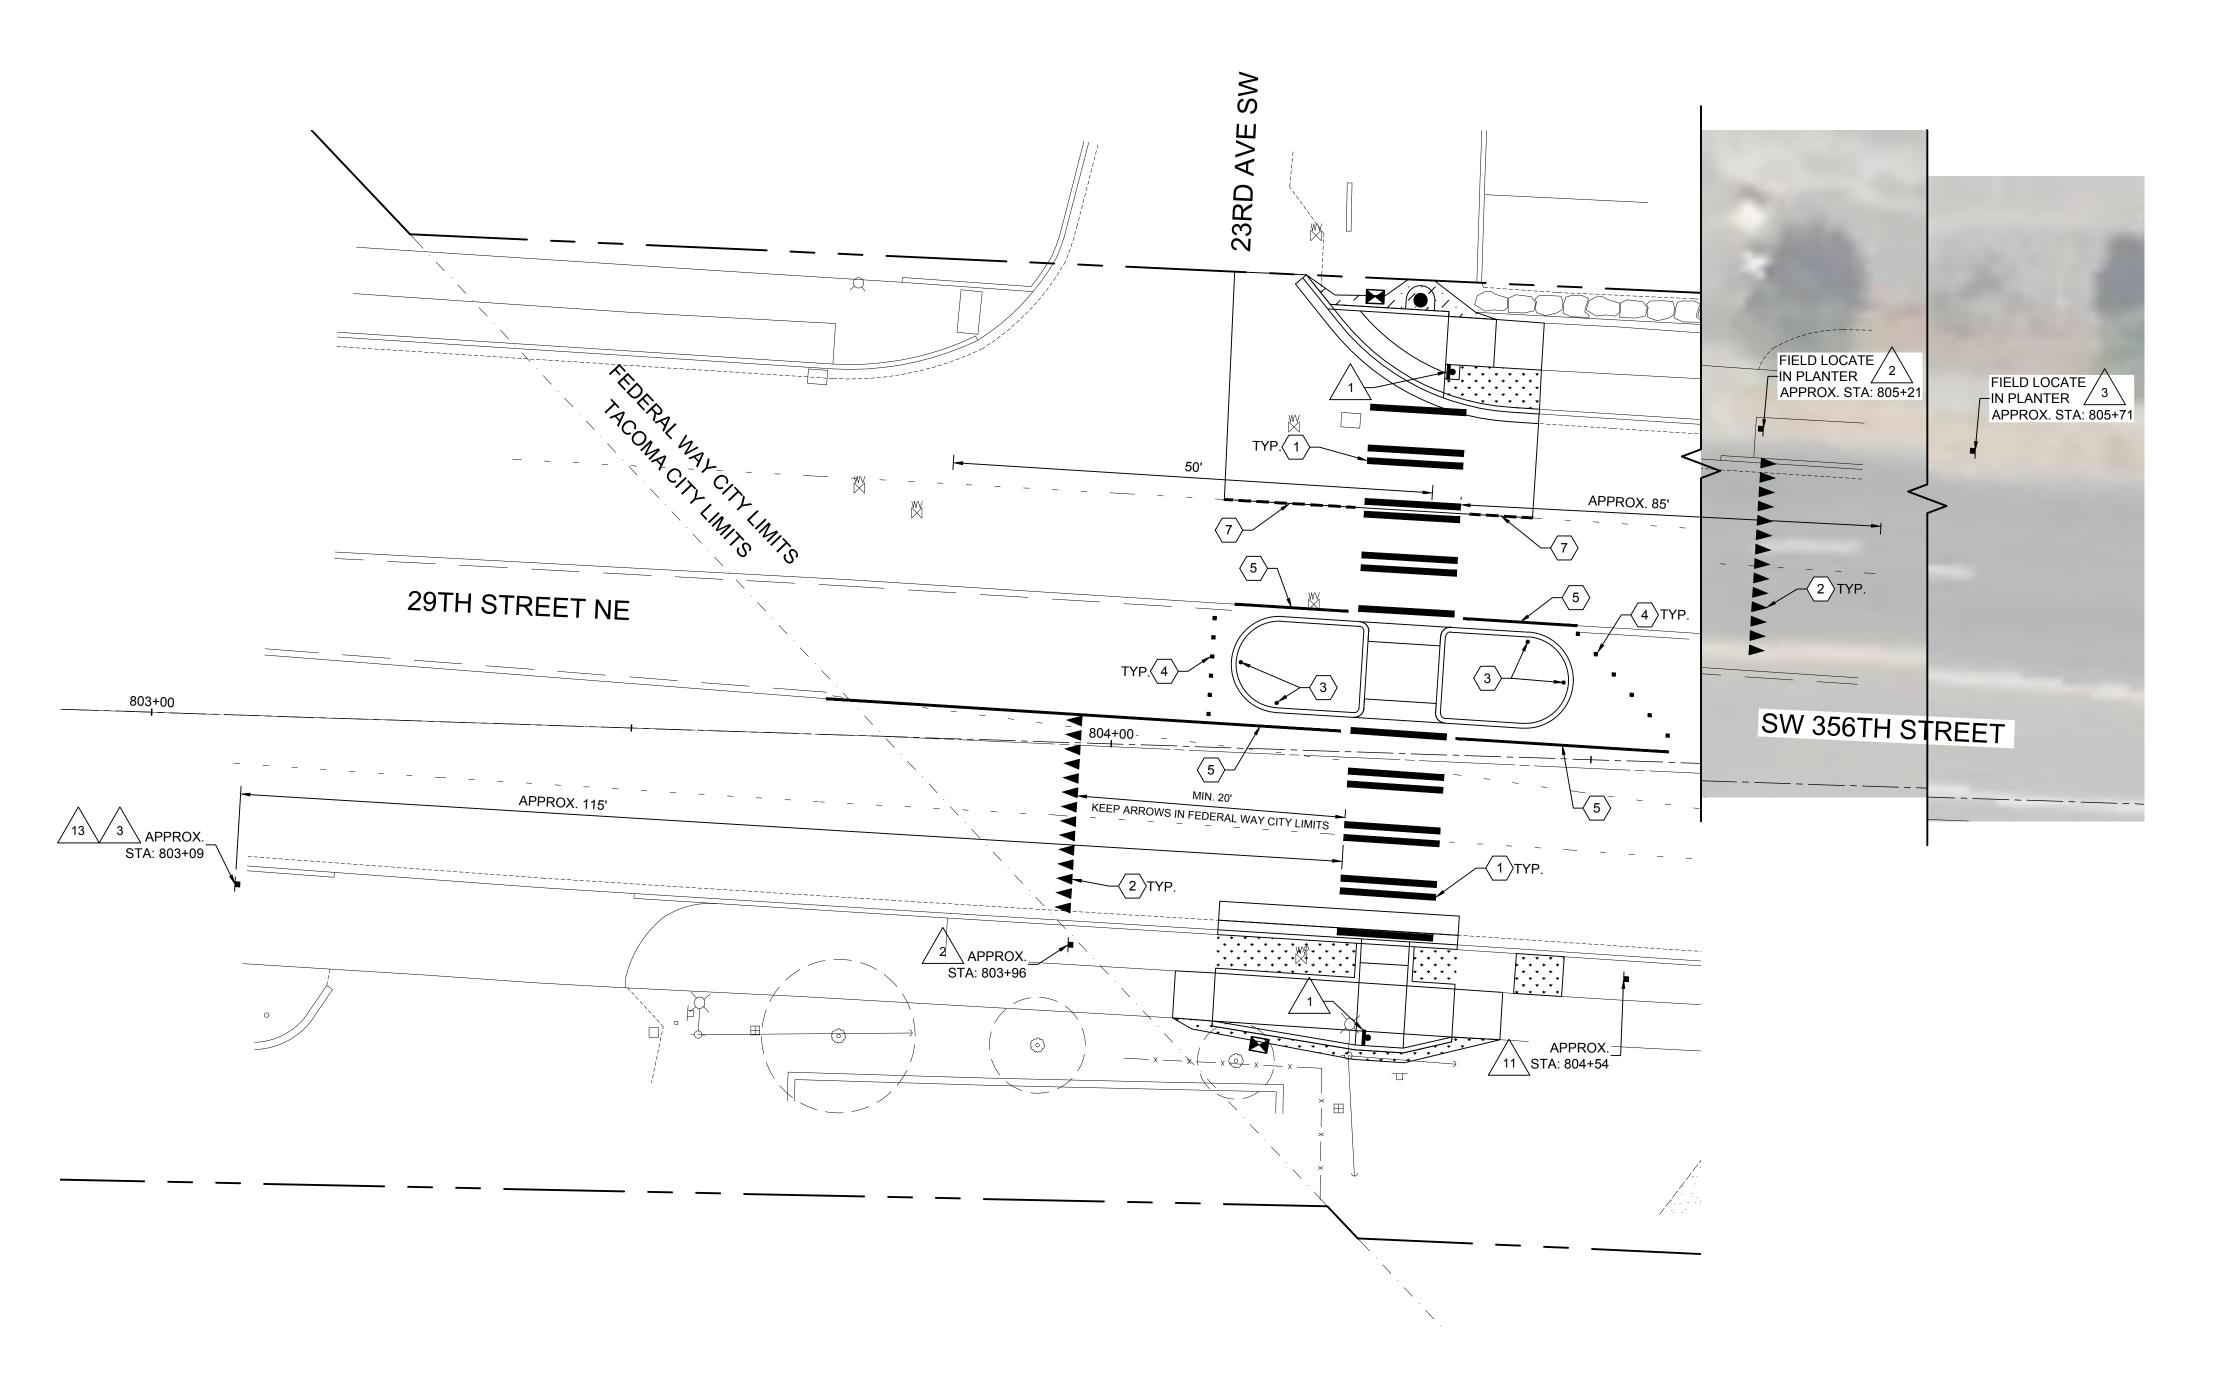
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CITYWIDE PEDESTRIAN SAFETY

PAVEMENT MARKING AND SIGNAGE PLAN LOCATION 7: SW 356TH ST AT 18TH AVE SW 100% DESIGN CITY PROJECT #

> SHEET C-307

36234



PAVEMENT MARKING NOTES:

- 1 PLASTIC CROSSWALK LINE PER CITY OF FEDERAL WAY DWG NO
- $\langle 2 \rangle$ PLASTIC TYPE 1 YIELD LINE SYMBOLS PER WSDOT STD PLAN M-24.60-04 LOCATED MINIMUM 50' IN ADVANCE OF MARKED
- (3) 28" TUBULAR MARKER. REFER TO SPECIAL PROVISIONS.
- 4 TYPE 2Y RPM. REFER TO SPECIAL PROVISIONS.
- 5 4" PLASTIC TYPE D EDGE LINE.
- 6 CONVERT REMAINDER OF TWO WAY LEFT TURN LANE TO DOUBLE YELLOW CENTER LINE PER CITY OF FEDERAL WAY DWG NO 3-17.
- 7 4" PLASTIC TYPE D LANE LINE PER CITY OF FEDERAL WAY DWG NO

GENERAL SIGNAGE NOTES:

- 1. INSTALL SIGNS IN ACCORDANCE WITH FEDERAL WAY DWG NO 3-17 AND 3-18. SIGNS WITHIN EXISTING SIDEWALK SHALL BE SURFACE MOUNTED.
- 2. EDGE OF SIGN SHALL BE A MINIMUM OF 2' FROM FACE OF CURB AND BOTTOM OF SIGN SHALL BE A MINIMUM OF 7' ABOVE FINISHED GRADE.

SIGNAGE NOTES:

1\RRFB ASSEMBLY. REFER TO RRFB PLANS.

 $^{\prime}$ $_{2}$ YIELD HERE TO PEDESTRIANS SIGN (R1-5A). ALIGN WITH YIELD LINE

/ 3 \ PEDESTRIAN SIGN (W11-2). LOCATE MINIMUM 100' IN ADVANCE OF MARKED CROSSWALK.

 $^{\prime}$ 4 $^{\setminus}$ RELOCATED SR509 NORTH SIGN.

5 \ APPROXIMATE LOCATION OF EXISTING SCHOOL ZONE AHEAD SIGN.

6 PEDESTRIAN SIGN (W11-2). LOCATE MINIMUM 100' IN ADVANCE OF EXISTING SCHOOL ZONE AHEAD SIGN.

RELOCATE EXISTING SCHOOL ZONE AHEAD SIGN MINIMUM 100' FROM MARKED CROSSWALK AND MINIMUM 100' IN ADVANCE OF SCHOOL ZONE.

8 RELOCATE EXISTING REDUCED SCHOOL SPEED LIMIT AHEAD SIGN MINIMUM 100' IN ADVANCE OF PEDESTRIAN WARNING SIGN.

9 PEDESTRIAN SIGN (W11-2). LOCATE MINIMUM 100' IN ADVANCE OF MARKED CROSSWALK.


10 RELOCATE EXISTING SPEED LIMIT SIGN MINIMUM 100' IN ADVANCE OF PROPOSED PEDESTRIAN SIGN.

/11ackslash RELOCATED WELCOME TO FEDERAL WAY SIGNS.

12\ RELOCATE EXISTING SPEED LIMIT SIGN MINIMUM 100' IN ADVANCE OF PEDESTRIAN SIGN.

/13\INSTALL ON SIDEWALK PER CITY OF TACOMA STANDARD PLAN

/14\ RELOCATE EXISTING STOP AHEAD SIGN MINIMUM 50' AFTER MARKED CROSSWALK.

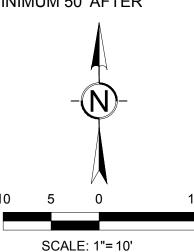



Know what's below.
Call before you dig. RFB #23-008

CITYWIDE PEDESTRIAN SAFETY

CITY PROJECT # 36234

100% DESIGN

PAVEMENT MARKING AND SIGNAGE PLAN

CITY OF Federal Way
Centered on Opportunity

33325 8TH AVE S FEDERAL WAY, WA 98003 PHONE: (253) 835-2700 WWW.CITYOFFEDERALWAY.COM



T 253.627.4367 F 253.627.4395

WWW.BCRADESIGN.COM

DRAFTED: RJB DESIGNED: MB/SMP REVIEWED: JBD APPROVED:

MARIE PO03/02/2023	NO.	DATE	REVISION	
A STATE OF THE STA				
M. M. M.				
58052				
SS/ONAL ENGINE				


DRAWING VERSION / REVISION LOG


LOCATION 8: SW 356TH ST AT 23RD AVE SW

26 of 37


SHEET

C-308

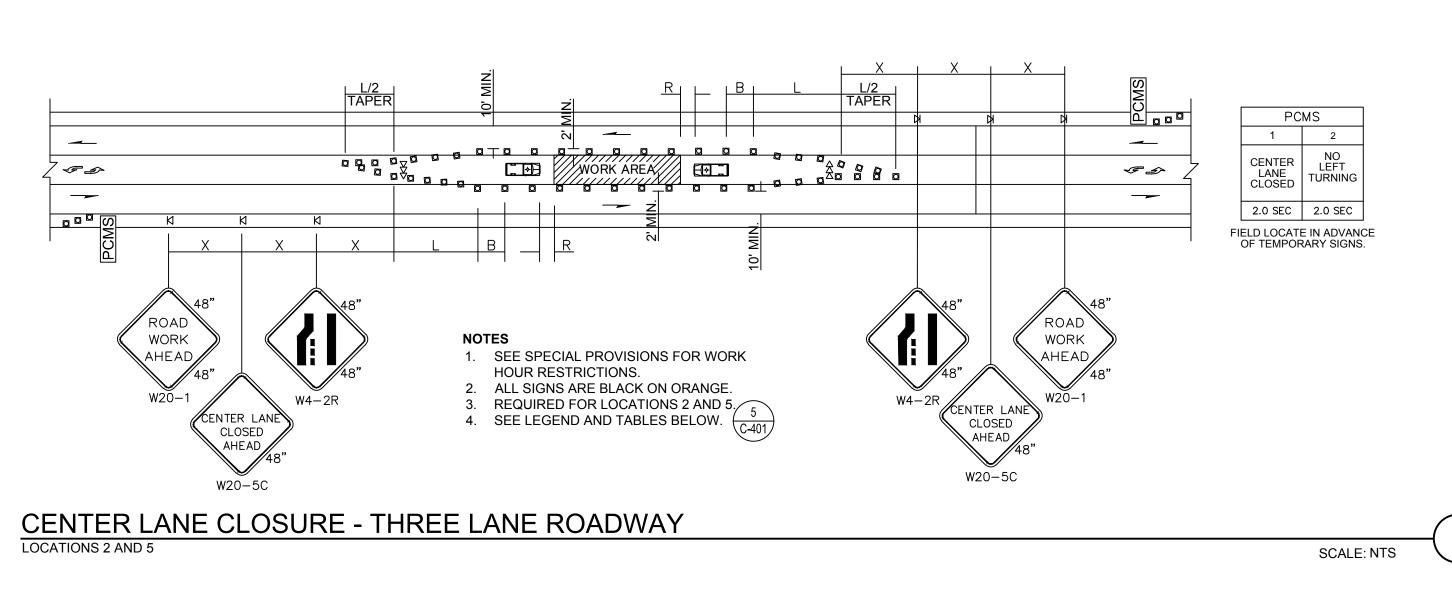

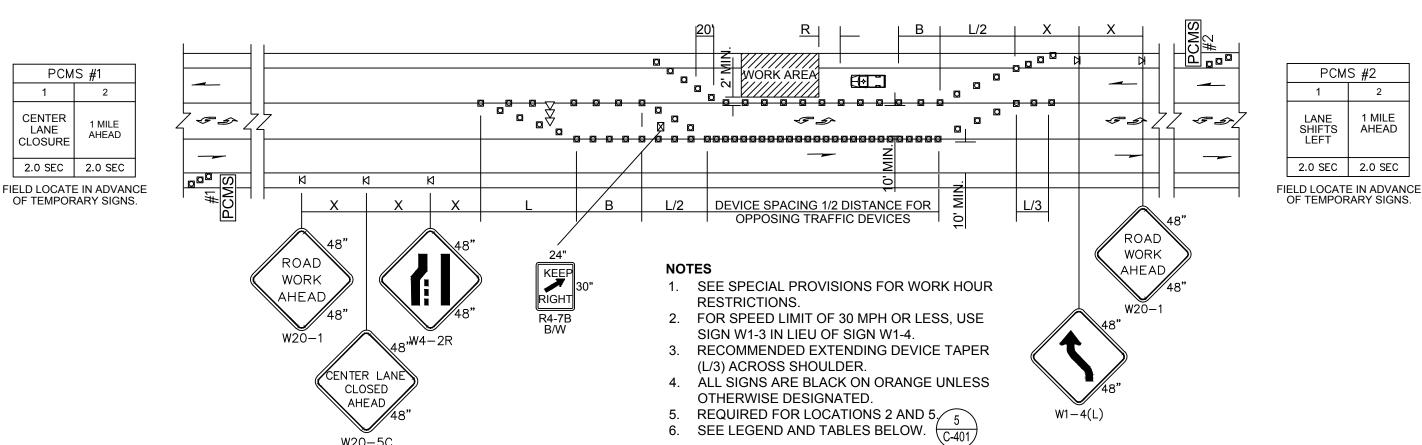



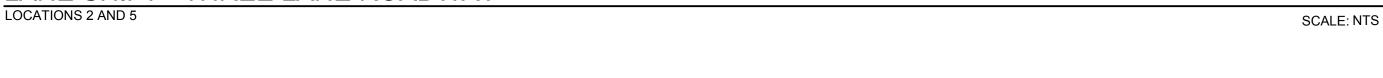

MINIMUM LANE CLOSURE TAPER LENGTH = L (feet)

10 | 105 | 150 | 205 | 270 | 450 | 500 | 550

115 165 225 295 495 550 605 660

12 125 180 245 320 540 600 660 720 780 840

 8'
 40
 40
 60
 90
 120
 130
 150
 160
 170
 190

10' 40 60 90 90 150 170 190 200 220 240

USE A MINIMUM 3 DEVICES TAPER FOR SHOULDER LESS THEN 8'.


MINIMUM SHOULDER TAPER LENGTH = L/3 (feet)

Posted Speed (mph)

25 30 35 40 45 50 55 60 65 70

Posted Speed (mph)

25 30 35 40 45 50 55 60 65 70

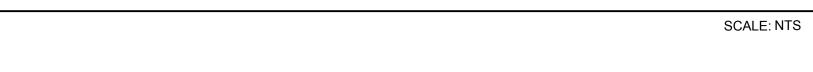

RURAL HIGHWAYS

RURAL ROADS

FREEWAYS & EXPRESSWAYS

ROADWAY CONDITIONS.

RESIDENTIAL & BUSINESS DISTRICTS

 CHANNELIZATION DEVICE SPACING (feet)

 MPH
 TAPER
 TANGENT

 50/70
 40
 80

 35/45
 30
 60

RAMPS, AT-GRADE INTERSECTIONS AND DRIVEWAYS.


(2) THIS SPACING MAY BE REDUCED IN URBAN AREAS TO FIT

SIGN SPACING = X (1)

55 / 70 MPH

60 / 65 MPH

45 / 55 MPH

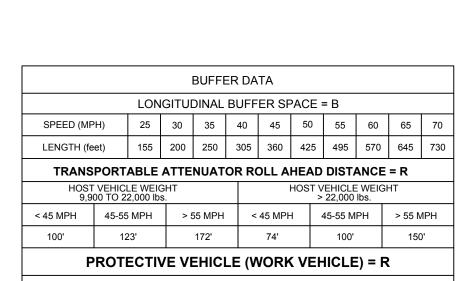

LOCATIONS 1, 3, 4, 6, 7, AND 8

LANE CLOSURE LEGEND AND TABLES



LEGEND

M TEMPORARY SIGN LOCATION

CHANNELIZING DEVICES

▼ TRAFFIC SAFETY DRUM

SEQUENTIAL ARROW SIGN

PCMS PORTABLE CHANGEABLE MESSAGE SIGN


▼ TEMPORARY SIGN LOCATION (5' MOUNTING HEIGHT)


PROTECTIVE VEHICLE

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GENERAL NOTES:

1. SEE SPECIAL PROVISIONS FOR WORK HOUR RESTRICTIONS. 2. OVERNIGHT LANE CLOSURES ARE NOT ALLOWED. FOR CURB AND GUTTER REPLACEMENTS, REMOVE PAVEMENT 1' FROM EDGE OF GUTTER AND BACKFILL WITH CSTC TO WITHIN 0.2' OF ADJACENT PAVEMENT GRADE AT END OF DAY.




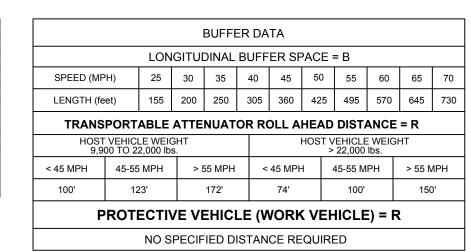

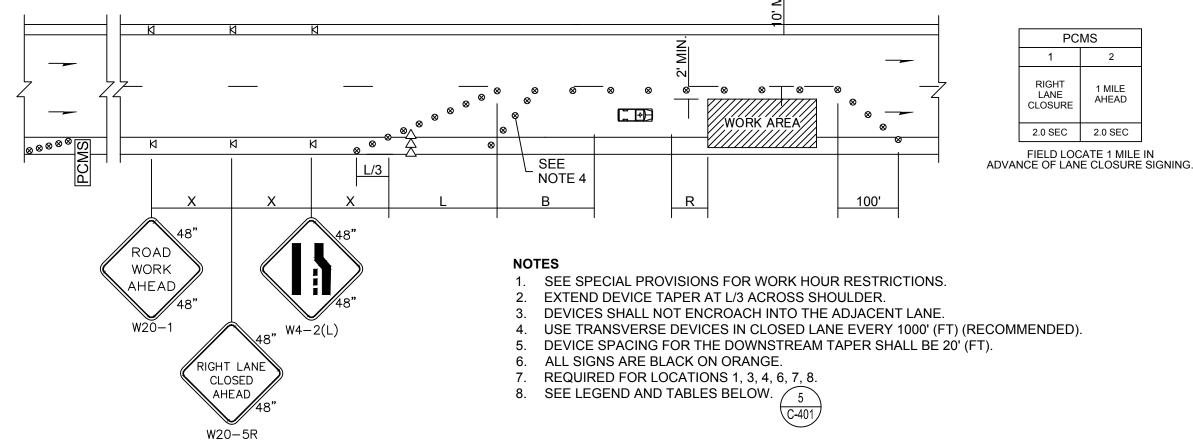SINGLE-LANE CLOSURE FOR MUTI-LANE ROADWAYS

SCALE: NTS

SCALE: NTS

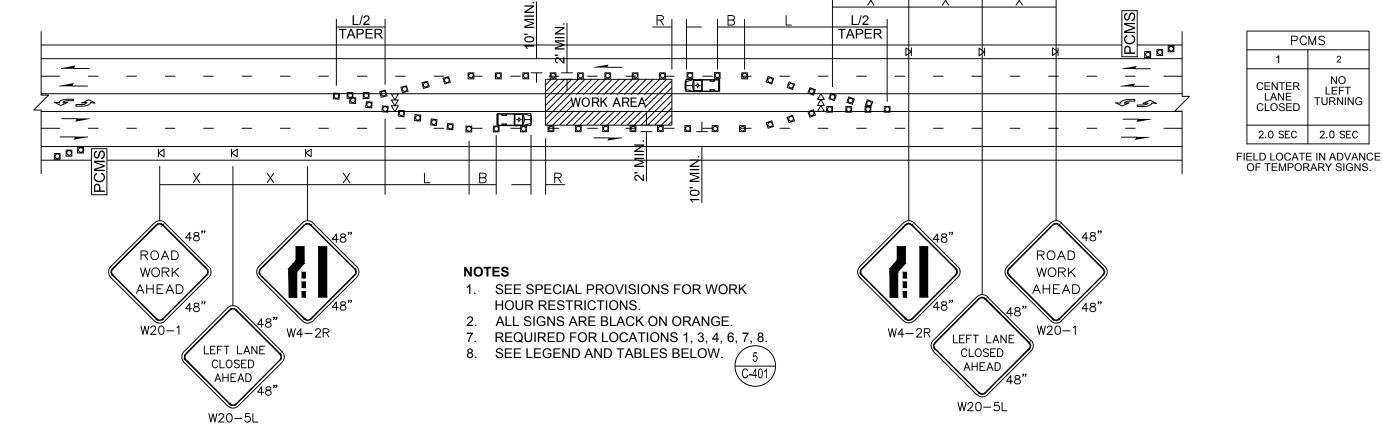

LEFT AND CENTER TURN LANE CLOSURE

- CURB AND GUTTER -HOT MIX ASPHALT (HMA) CLASS 1/2" WITH PERFORMANCE GRADE 58H-22 ASPHALT BINDER. MATCH EXISTING PAVEMENT DEPTH EXISTING ASPHALT PAVEMENT - SEE NOTE 1. GRADE AND COMPACT EXISTING BASE ROCK TO MEET DESIGN GRADES. IF ADDITIONAL ROCK IS NEEDED, SUPPLEMENT WITH CRUSHED SURFACING BASE COURSE.

1. IF EXISTING BASE ROCK IS UNSUITABLE FOR REGRADING AND COMPACTION REPLACE BASE ROCK WITH NEW CRUSHED SURFACING BASE COURSE TO SUBGRADE. MATCH EXISTING ROCK AND ASPHALT DEPTHS

HMA PAVEMENT

100% DESIGN CITY PROJECT #




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DRAFTED: RJB

TACOMA, WA 98402

DESIGNED: MB/SMP REVIEWED: JBD 2106 PACIFIC AVENUE, SUITE 300, T 253.627.4367 F 253.627.4395 APPROVED: WWW.BCRADESIGN.COM

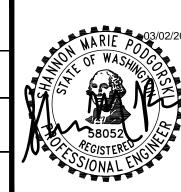

	DRAWING VERSION / REVISION LOG			
MARIE PO03/02/2023	NO.	DATE	REVISION	
Z Z SAINCOR				
Y" MELL				
58052				
SS/ONAL ENGIN				
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CITYWIDE PEDESTRIAN SAFETY

DETAILS AND TRAFFIC CONTROL


36234 SHEET


C-401

27 OF 37

- FW RRFB SIGNAL STANDARD POLE WITH SINGLE OR DOUBLE SIDED SOLAR RRFB ASSEMBLY PER PLAN, PER WSDOT IS-22 (SHEET 2 OF 2), AND PER SHEET IL-109.
- $\langle 2 \rangle$ REMOVE EXISTING POLE AND FOUNDATION. CAP CONDUITS.
- 3 STANDARD TYPE III MAST ARM POLE PER WSDOT IS-13B AND PER SHEETS IL-109 AND IL-110 WITH SOLAR RRFB ASSEMBLY.
- SIGNAL STANDARD FOUNDATION PER WSDOT J-26.15-01 (SHEET 3 OF 3) "FOUNDATION WITHIN THE SIDEWALK SECTION OR TRAFFIC ISLAND SECTION" AND WSDOT J-26.10-03. TOP OF FOUNDATION SHALL BE FINISHED FLUSH WITH ADJACENT SIDEWALK.
- FW RRFB SIGNAL STANDARD POLE FOUNDATION IN ACCORDANCE WITH THE RRFB FOUNDATION DETAIL ON SHEET |L-110|.
- $\langle 8 \rangle$ CONTRACTOR SHALL POTHOLE AND NOTIFY ENGINEER IF CONFLICT EXISTS.
- (9) INSTALL NEW CONDUIT INTO EXISTING JUNCTION BOX.
- REPLACE JUNCTION BOX WITH NEW JUNCTION BOX WITH SLIP RESISTANT LID IN NEW LOCATION. INTERCEPT EXISTING CONDUIT RUN AND EXTEND TO NEW JUNCTION BOX. CONTRACTOR TO VERIFY CONDUIT SIZE AND TYPE AND SUPPLY ANY NECESSARY ADAPTOR FITTINGS. PROTECT EXISTING CONDUCTORS AND PULL INTO TO NEW JUNCTION BOX PER PLAN.
- $\langle 21 \rangle$ Splice New and existing lighting conductors for New Street light added to existing circuit.

LEGEND:	PROPOSED
STREET LIGHT	—
MAST ARM POLE	
FW RRFB POLE	O
PED PUSH BUTTON	4
CONSTRUCTION NOTE	$\langle 1 \rangle$
WIRE NOTE	1
UNDERGROUND CONDUIT	
TYPE 1 JB	
TYPE 2 JB	
SERVICE ENCLOSURE	
OVERHEAD RRFB/SIGN	
POST MOUNTED RRFB/SIGNS	

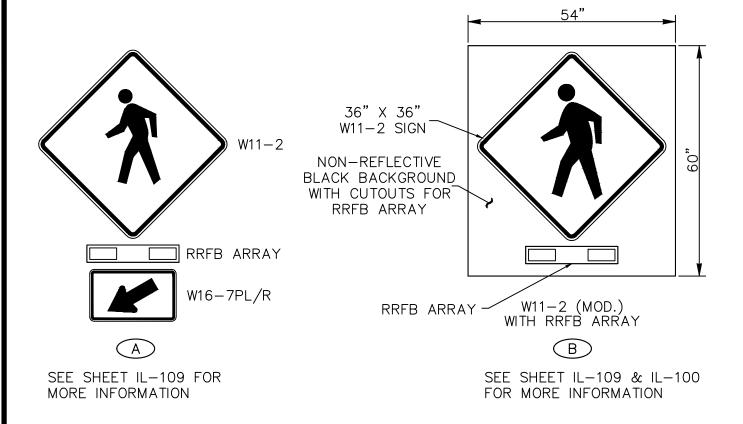

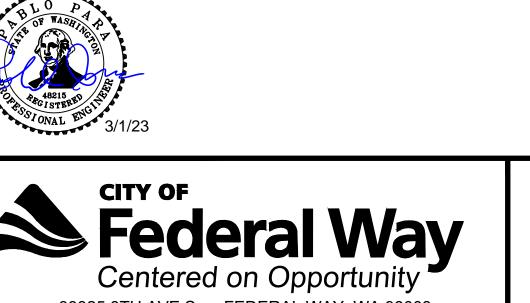

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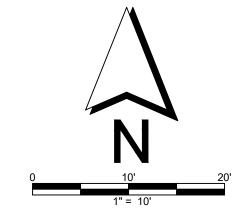


DRAFTED:	ER	
DESIGNED:	MT	
REVIEWED:	PP	PH CONSU
APPROVED:		

	DRAWING VERSION / REVISION LOG			
	NO.	DATE	REVISION	
PH CONSULTING				

GENERAL NOTES:

- 1. JUNCTION BOXES INSTALLED OUTSIDE OF THE SIDEWALK SHALL BE SURROUNDED BY A CONCRETE PAD PER CITY OF FEDERAL WAY STANDARD DRAWING 3—39A.
- 2. NEW POLES WITH LUMINAIRES SHALL BE NUMBERED PER FEDERAL WAY STANDARD DRAWING NUMBER 3-39B.



APN 08210 HARSCH INVESTMI		APN 082104-9082 LAUREN JOO	
50.0	8"DEC. — T(UG) — T(UG) — T(UG) — T(UG) — P(UG) — P(UG	T(UG) T(UG)	P(UG)
	S. 119+00	320TH STREET	ANS 915
50.07	G G G G G G G G G G G G G G G G G G G	B G G G G G G G G G G G G G	— G — G — G — G — G — G — G — G — W — W
	APN 150050-0040 MERLONE GEIER PARTNERS	9	APN 150050-0110 HARSCH INVESTMENT PROPS

WIRING SCHEDULE

PPB CABLE

1

1

1

Note 4. Conduits installed under travelled way shall be schedule 80. All other conduits shall be schedule 40.

RUN

NO.

NEW 2"

NEW 2"

NEW 2"

NEW 2"

NEW 2"

NEW 2"

Note 1. Only proposed conductors shown.

between the Wiring Schedule and the field conditions.

Note 2. Ground wire shall be equal to or larger than largest conductor in conduit.

2 NEW 2"

3 NEW 2"

5 NEW 1"

4 EX.

CONDUIT SIZE/TYPE

ILLUM GRND

2

2

2 EX.

2

Note 3. New circuit wiring shall be aluminum. For lights installed on existing circuits, wiring material shall match existing wiring material (copper or aluminum) and shall match existing wiring size. Contractor shall notify engineer if there is a discrepancy

#8

1

1

PULL TAPE

COMMENTS

SPARE

SPARE

SPARE

CITYWIDE PEDESTRIAN SAFETY

RRFB SYSTEM

LOCATION 1: S 320TH ST - 1400 BLOCK


SHEET IL - 101

CITY PROJECT #


36234

- $\langle 1 \rangle$ FW RRFB SIGNAL STANDARD POLE WITH SINGLE OR DOUBLE SIDED SOLAR RRFB ASSEMBLY PER PLAN, PER WSDOT IS-22 (SHEET 2 OF 2), AND PER SHEET IL-109.
- $\langle 8 \rangle$ CONTRACTOR SHALL POTHOLE AND NOTIFY ENGINEER IF CONFLICT EXISTS.
- 9 INSTALL NEW CONDUIT INTO EXISTING JUNCTION BOX.
- (10) ABANDON LOOP.
- FW RRFB SIGNAL STANDARD POLE FOUNDATION IN ACCORDANCE WITH THE RRFB CURB FOUNDATION DETAIL ON SHEET IL-110.

LEGEND:	PROPOSED
	T NOI OSLD
STREET LIGHT	•
MAST ARM POLE	0
FW RRFB POLE	O
PED PUSH BUTTON	4
CONSTRUCTION NOTE	$\langle 1 \rangle$
WIRE NOTE	1
UNDERGROUND CONDUIT	
TYPE 1 JB	
TYPE 2 JB	
SERVICE ENCLOSURE	
OVERHEAD RRFB/SIGN	
POST MOUNTED RRFB/SIGNS	<u> </u>

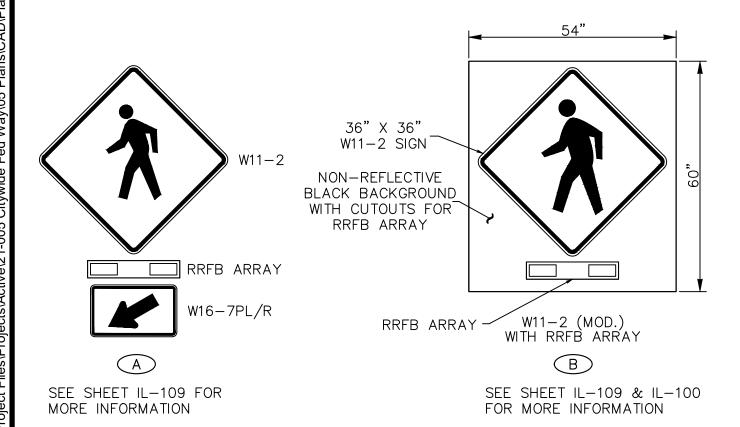



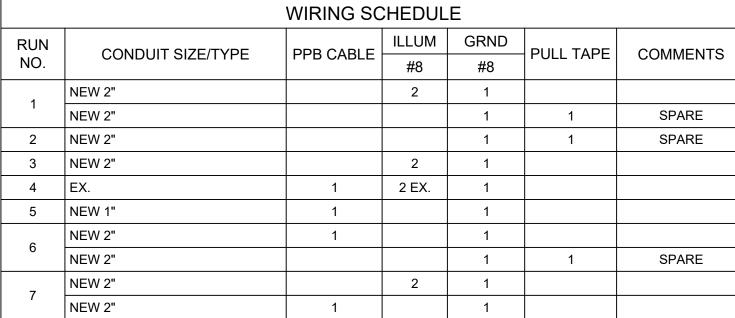

Note 1. Only proposed conductors shown.

Note 2. Ground wire shall be equal to or larger than largest conductor in conduit.


Note 3. New circuit wiring shall be aluminum. For lights installed on existing circuits, wiring material shall match existing wiring material (copper or aluminum) and shall match existing wiring size. Contractor shall notify engineer if there is a discrepancy between the Wiring Schedule and the field conditions.

Note 4. Conduits installed under travelled way shall be schedule 80. All other conduits shall be schedule 40.

GENERAL NOTES:

1. JUNCTION BOXES INSTALLED OUTSIDE OF THE SIDEWALK SHALL BE SURROUNDED BY A CONCRETE PAD PER CITY OF FEDERAL WAY STANDARD DRAWING 3-39A.

2. NEW POLES WITH LUMINAIRES SHALL BE NUMBERED PER FEDERAL WAY STANDARD DRAWING NUMBER 3-39B.

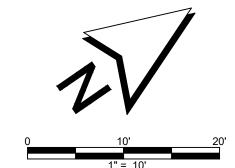

APN 122103-9006 RHB MIRO OWNER LLC	T(UG) T(UG)		APN 18 DASH POIN	9880-0010 T VILLAGE LLC	
40.0° — G	$\begin{array}{c ccccccccccccccccccccccccccccccccccc$		A A T(UG) T(UG) T(UG) T W W W W W W W W W W W W W W W W W W	- W — W — W — W — W — W — W — W — W — W	W W W W W W W W W W W W W W W W W W W
			SW DASH PT. ROAD	(SR 509)	
200+00			bij bij		201+00
-42.0°		19 (UG) (S) (S) (S) (S) (S) (S) (S) (S) (S) (S	-50 - 50 - 50 - 50 - 50 - 50 $-55 - 55 - 55 - 55 - 55$	282.56 SD	



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DRAFTED:

DESIGNED:

REVIEWED:

APPROVED:

ER	
MT	
PP	PH CONSUI

		DRAWI	NG VERSION / REVISION LOG	
	NO.	DATE	REVISION	
H CONSULTING				

CITYWIDE	PEDESTRIAN	SAFETY	
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SHEET

RRFB SYSTEM LOCATION 2: SR 509 SOUTH OF 16TH AVE SW

IL-102

29 of 37


CITY PROJECT #

36234


- 5 SIGNAL STANDARD FOUNDATION PER WSDOT J-26.10-03. IF FOUNDATION IS ADJACENT TO CURB, TOP OF FOUNDATION SHALL BE FINISHED FLUSH WITH ADJACENT CURB VERTICALLY AND HORIZONTALLY.
- $\overline{\langle 7 \rangle}$ replace existing junction box in place with New Junction box with slip resistant Lid.
- EXISTING LUMEC ECOSWAP SYSTEM HAS ADJUSTMENT SWITCH TO CHANGE OPERATING WATTAGE. SWITCH TO OPERATE AT 65W RATHER THAN 40W.
- STANDARD TYPE II MAST ARM POLE PER WSDOT IS-13B AND PER SHEETS IL-109 AND IL-110 WITH SOLAR RRFB ASSEMBLY.
- INSTALL PEDESTRIAN PUSH BUTTON POST AND PUSH BUTTON PER WSDOT STANDARD PLAN J-20.10-04 WITH CURB BASE FOUNDATION PER WSDOT STANDARD PLAN J-20.11-03.
- ON SIDE OF POLE WITH BANDED SIDE POLE MOUNT.

LEGEND:	PROPOSED
STREET LIGHT	—
MAST ARM POLE	O .
FW RRFB POLE	
PED PUSH BUTTON	4
CONSTRUCTION NOTE	$\langle 1 \rangle$

	T NOT OSED
STREET LIGHT	• •
MAST ARM POLE	
FW RRFB POLE	O
PED PUSH BUTTON	4
CONSTRUCTION NOTE	1
WIRE NOTE	1
UNDERGROUND CONDUIT	
TYPE 1 JB	
TYPE 2 JB	
SERVICE ENCLOSURE	
OVERHEAD RRFB/SIGN	
POST MOUNTED RRFB/SIGNS	<u> </u>

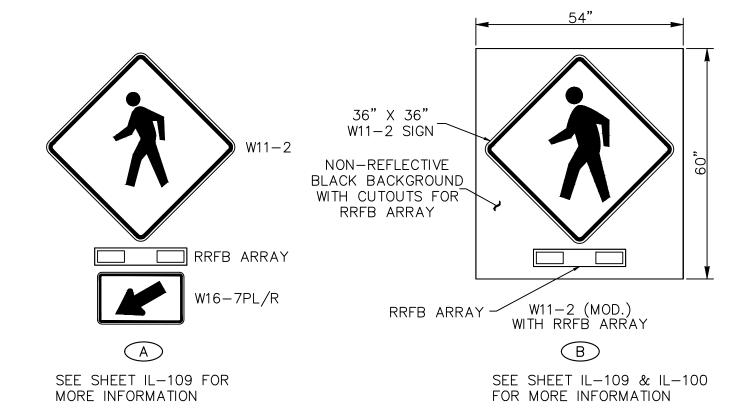



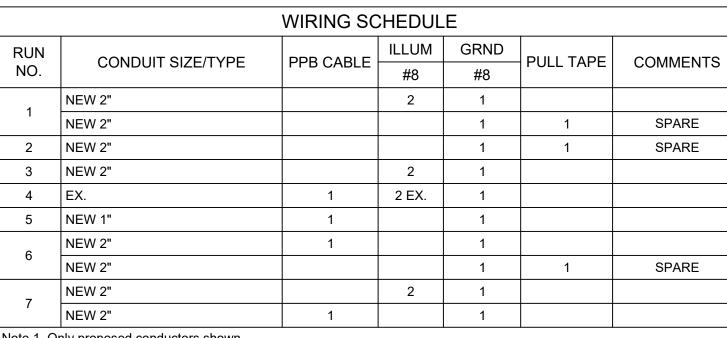

Note 1. Only proposed conductors shown.

Note 2. Ground wire shall be equal to or larger than largest conductor in conduit.


Note 3. New circuit wiring shall be aluminum. For lights installed on existing circuits, wiring material shall match existing wiring material (copper or aluminum) and shall match existing wiring size. Contractor shall notify engineer if there is a discrepancy between the Wiring Schedule and the field conditions.

Note 4. Conduits installed under travelled way shall be schedule 80. All other conduits shall be schedule 40.

GENERAL NOTES:

1. JUNCTION BOXES INSTALLED OUTSIDE OF THE SIDEWALK SHALL BE SURROUNDED BY A CONCRETE PAD PER CITY OF FEDERAL WAY STANDARD DRAWING 3-39A.

2. NEW POLES WITH LUMINAIRES SHALL BE NUMBERED PER FEDERAL WAY STANDARD DRAWING NUMBER 3-39B.

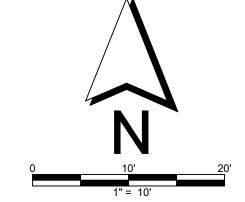

AVENUE S			APN 78 JANG	5360-0065 LEE LLC STA: 301+30.08_ OFF: 37.00'L		
18TH	P(UG) P(UG) P(UG)	P(UG) P(UG) P(UG) - POWER P(UG) P(UG) P(UG)	P(UG) — P(UG)	G) P(Us) P(Us) P 5 R(Us) R T T 8	P(UG)	— P(UG) —— P
WY W W TOUGH		w — w — w — w — w — w —	- w - w - w - w - w	w — w — w — w — w — w —	13\\(20\) A \\ \(- \times -	— w — w — w — w — w — w —
P(US) P(US)		S. 312TH	I STREET		В	
	T(UC)		301+00	//5121	H STREE	
	T(NC) T(NC) P(NC) (S)			(18) (18)		<u> </u>
	T(UG)	T(UG) — T(UG)	I(UG) T(UG)	A T(UC) SOLETION SOLETIO	(ug) T(ug) T	T(UG) — P(UG) — P(UG) — P(UG) — P(UG) — T(UG)
6"DEC.	— P(UG)	P(UG) P(UG) - T(UG) - TEL. RISER	P(UG) — P(UG) — P(UG)	STA: 301+32.56_ OFF: 37.87'R	P(UG) P(UG) P(UG)	P(UG) —— P(UG) —— P(UG) ——
	POWER VAULT	7(APN 092104-9125 WALMART INC.	LIGHT JBOX	T(UG) — T(UG) -	T(UG) — T(UG)

•	CITY OF
	Federal Way
·	Centered on Opportunity

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DRAFTED: ER

DESIGNED: MT

REVIEWED: PP

APPROVED:

PH CONSUL ⁻

		DRAWI	NG VERSION / REVISION LOG
	NO.	DATE	REVISION
H CONSULTING			

CITYWIDE PEDESTRIAN SAFETY


CITY PROJECT # 36234

RRFB SYSTEM LOCATION 3: S 312TH ST AT 18TH AVE S IL-103

SHEET

- \langle 1 \rangle FW RRFB SIGNAL STANDARD POLE WITH SINGLE OR DOUBLE SIDED SOLAR RRFB ASSEMBLY PER PLAN, PER WSDOT IS-22 (SHEET 2 OF 2), AND PER SHEET IL-109.
- 3 STANDARD TYPE III MAST ARM POLE PER WSDOT IS-13B AND PER SHEETS IL-109 AND IL-110 WITH SOLAR RRFB ASSEMBLY.
- 4 SIGNAL STANDARD FOUNDATION PER WSDOT J-26.15-01 (SHEET 3 OF 3) "FOUNDATION WITHIN THE SIDEWALK SECTION OR TRAFFIC ISLAND SECTION" AND WSDOT J-26.10-03. TOP OF FOUNDATION SHALL BE FINISHED FLUSH WITH ADJACENT SIDEWALK.
- FW RRFB SIGNAL STANDARD POLE FOUNDATION IN ACCORDANCE WITH THE RRFB FOUNDATION DETAIL ON SHEET |L-110|.
- (8) CONTRACTOR SHALL POTHOLE AND NOTIFY ENGINEER IF CONFLICT EXISTS.
- $\langle 9 \rangle$ INSTALL NEW CONDUIT INTO EXISTING JUNCTION BOX.
- $\langle 11 \rangle$ Install New Junction Box with SLIP RESISTANT LID.
- $\langle 21 \rangle$ Splice New and existing lighting conductors for New Street light added to existing circuit.

LEGEND:	PROPOSED
STREET LIGHT	•
MAST ARM POLE	0
FW RRFB POLE	Ø
PED PUSH BUTTON	4
CONSTRUCTION NOTE	1
WIRE NOTE	$\sqrt{1}$
UNDERGROUND CONDUIT	
TYPE 1 JB	
TYPE 2 JB	
SERVICE ENCLOSURE	
OVERHEAD RRFB/SIGN	
POST MOUNTED RRFB/SIGNS	_

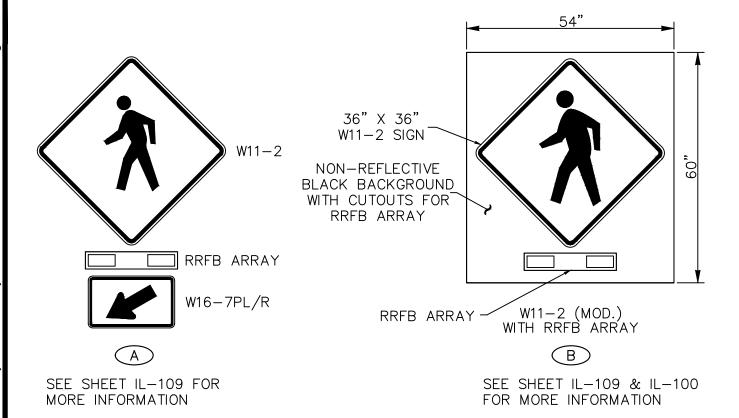

		WIRING SC	CHEDUL	.E		
RUN	CONDUIT CIZE/TVDE	DDD CADLE	ILLUM	GRND	PULL TAPE	OOMANAENITO
NO.	CONDUIT SIZE/TYPE	PPB CABLE	#8	#8	PULL TAPE	COMMENTS
1	NEW 2"		2	1		
ļ	NEW 2"			1	1	SPARE
2	NEW 2"			1	1	SPARE
3	NEW 2"		2	1		
4	EX.	1	2 EX.	1		
5	NEW 1"	1		1		
6	NEW 2"	1		1		
0	NEW 2"			1	1	SPARE
7	NEW 2"		2	1		
/	NEW 2"	1		1		
Note 1. O	only proposed conductors shown.	•	•	•		
Note 2 G	round wire shall be equal to or larger t	han largest condu	ictor in con	duit		

Note 2. Ground wire shall be equal to or larger than largest conductor in conduit.


Note 3. New circuit wiring shall be aluminum. For lights installed on existing circuits, wiring material shall match existing wiring material (copper or aluminum) and shall match existing wiring size. Contractor shall notify engineer if there is a discrepancy between the Wiring Schedule and the field conditions.


Note 4. Conduits installed under travelled way shall be schedule 80. All other conduits shall be schedule 40.

GENERAL NOTES:

1. JUNCTION BOXES INSTALLED OUTSIDE OF THE SIDEWALK SHALL BE SURROUNDED BY A CONCRETE PAD PER CITY OF FEDERAL WAY STANDARD DRAWING 3-39A.

2. NEW POLES WITH LUMINAIRES SHALL BE NUMBERED PER FEDERAL WAY STANDARD DRAWING NUMBER 3-39B.

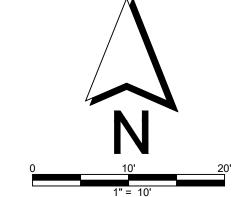

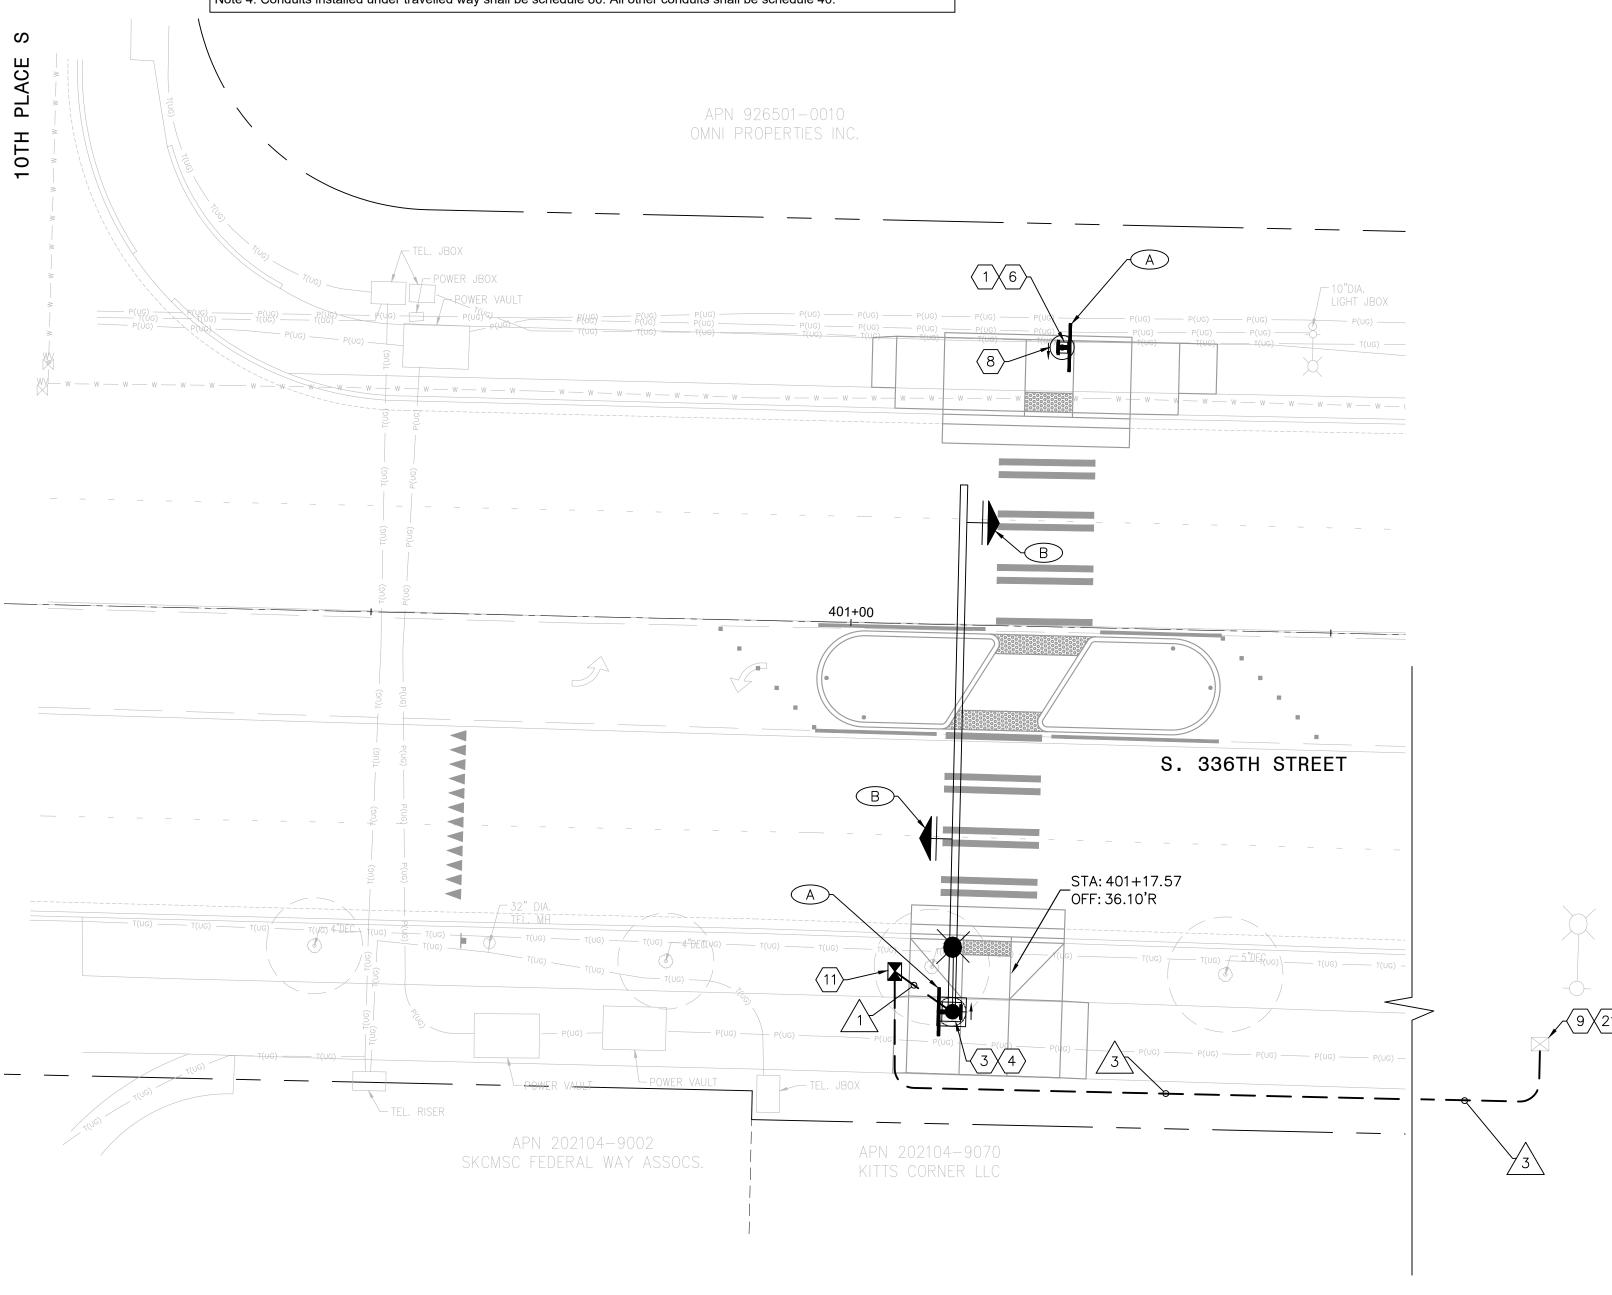



CITY OF Federal Way
Centered on Opportunity 33325 8TH AVE S FEDERAL WAY, WA 98003

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SIGNED:	MT	
/IEWED:	PP	PH CONS

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	NO.	DATE	REVISION	
PH CONSULTING				

CITYWIDE	PEDESTRIAN	N SAFETY
R	RFB SYSTEM	

36234 SHEET

CITY PROJECT 7

IL-104 LOCATION 4: 336TH ST AT 10TH PL S


31 of 37

Know what's **below.**


- FW RRFB SIGNAL STANDARD POLE WITH SINGLE OR DOUBLE SIDED SOLAR RRFB ASSEMBLY PER PLAN, PER WSDOT IS-22 (SHEET 2 OF 2), AND PER SHEET IL-109.
- FW RRFB SIGNAL STANDARD POLE FOUNDATION IN ACCORDANCE WITH THE RRFB FOUNDATION DETAIL ON SHEET |L-110|.
- $\langle 8 \rangle$ contractor shall pothole and notify engineer if conflict exists.
- LIGHT FIXTURE/POLE TO BE UPGRADED BY OTHERS. CONTRACTOR SHALL COORDINATE WITH PSE ON WORK PHASING TO ENSURE LIGHT IS UPGRADED BY THE TIME THE NEW PEDESTRIAN CROSSING IS FUNCTIONING.

LEGEND:	PROPOSED
STREET LIGHT	•
MAST ARM POLE	
FW RRFB POLE	
PED PUSH BUTTON	4
CONSTRUCTION NOTE	$\langle 1 \rangle$
WIRE NOTE	1
UNDERGROUND CONDUIT	
TYPE 1 JB	
TYPE 2 JB	
SERVICE ENCLOSURE	
OVERHEAD RRFB/SIGN	
	•

POST MOUNTED RRFB/SIGNS

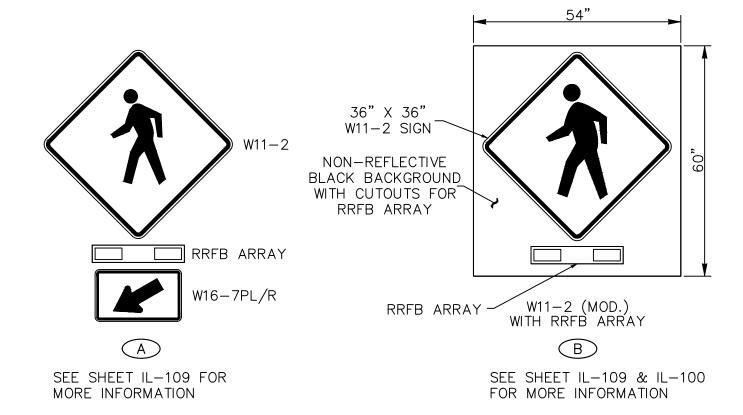



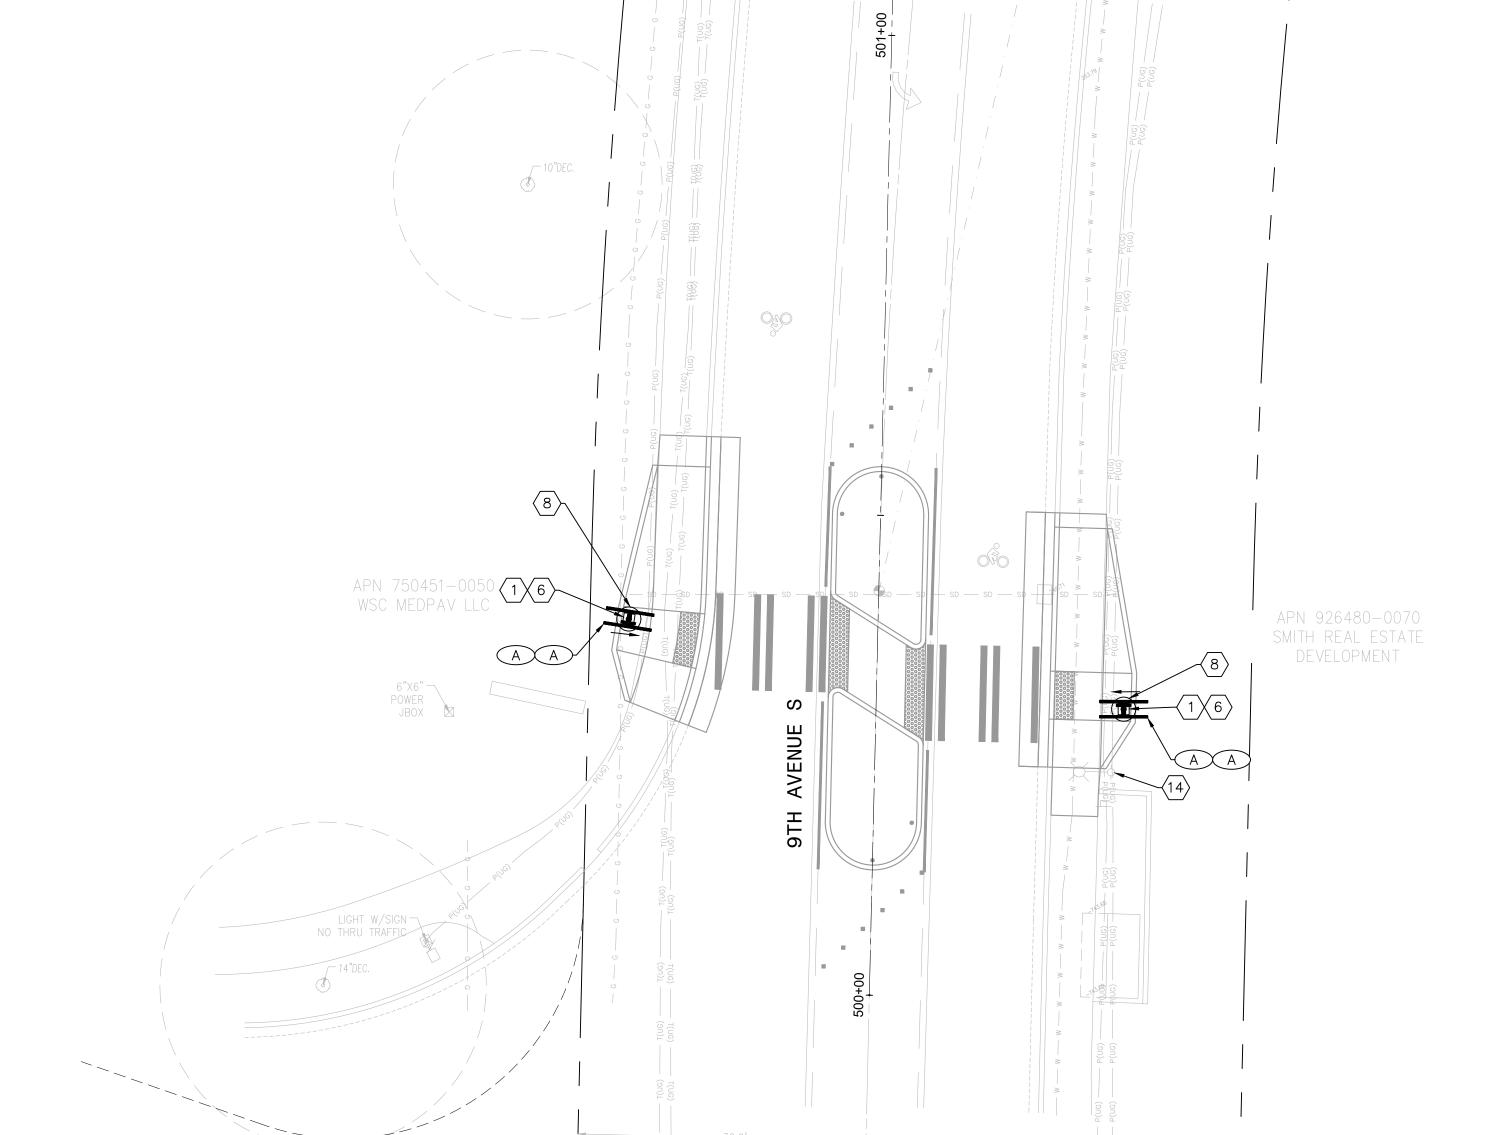



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ST. FRANCIS HOSPITAL

CITYWIDE PEDESTRIAN SAFETY

GENERAL NOTES:

STANDARD DRAWING 3-39A.

DRAWING NUMBER 3-39B.

1. JUNCTION BOXES INSTALLED OUTSIDE OF

THE SIDEWALK SHALL BE SURROUNDED BY A

CONCRETE PAD PER CITY OF FEDERAL WAY

2. NEW POLES WITH LUMINAIRES SHALL BE

NUMBERED PER FEDERAL WAY STANDARD

RRFB SYSTEM
LOCATION 5: 9TH AVE S AT ST. FRANCIS HOSPITAL


CITY PROJECT #:

IL-105

32 OF 37

- \langle 1 \rangle FW RRFB SIGNAL STANDARD POLE WITH SINGLE OR DOUBLE SIDED SOLAR RRFB ASSEMBLY PER PLAN, PER WSDOT IS-22 (SHEET 2 OF 2), AND PER SHEET IL-109.
- 3 STANDARD TYPE III MAST ARM POLE PER WSDOT IS-13B AND PER SHEETS IL-109 AND IL-110 WITH SOLAR RRFB ASSEMBLY.
- $\overline{\langle 4 \rangle}$ Signal standard foundation per wsdot J-26.15-01 (sheet 3 of 3) "foundation within the sidewalk SECTION OR TRAFFIC ISLAND SECTION" AND WSDOT J-26.10-03. TOP OF FOUNDATION SHALL BE FINISHED FLUSH WITH ADJACENT SIDEWALK.
- FW RRFB SIGNAL STANDARD POLE FOUNDATION IN ACCORDANCE WITH THE RRFB FOUNDATION DETAIL ON SHEET 1L-110.
- $\overline{\langle 7 \rangle}$ REPLACE EXISTING JUNCTION BOX IN PLACE WITH NEW JUNCTION BOX WITH SLIP RESISTANT LID.
- (8) CONTRACTOR SHALL POTHOLE AND NOTIFY ENGINEER IF CONFLICT EXISTS.
- REPLACE JUNCTION BOX WITH NEW JUNCTION BOX WITH SLIP RESISTANT LID IN NEW LOCATION. INTERCEPT EXISTING CONDUIT RUN AND EXTEND TO NEW JUNCTION BOX. CONTRACTOR TO VERIFY CONDUIT SIZE AND TYPE AND SUPPLY ANY NECESSARY ADAPTOR FITTINGS. PROTECT EXISTING CONDUCTORS AND PULL INTO TO NEW JUNCTION BOX PER
- (17) ORIENT POLE SUCH THAT HANDHOLE FACES THE STREET FOR EASE OF ACCESS.
- $\langle 21 \rangle$ SPLICE NEW AND EXISTING LIGHTING CONDUCTORS FOR NEW STREET LIGHT ADDED TO EXISTING CIRCUIT.

I FOEND.	
LEGEND:	PROPOSED
STREET LIGHT	•
MAST ARM POLE	O `
FW RRFB POLE	O
PED PUSH BUTTON	4
CONSTRUCTION NOTE	$\langle 1 \rangle$
WIRE NOTE	1
UNDERGROUND CONDUIT	
TYPE 1 JB	
TYPE 2 JB	
SERVICE ENCLOSURE	
OVERHEAD RRFB/SIGN	
POST MOUNTED RRFB/SIGNS	_

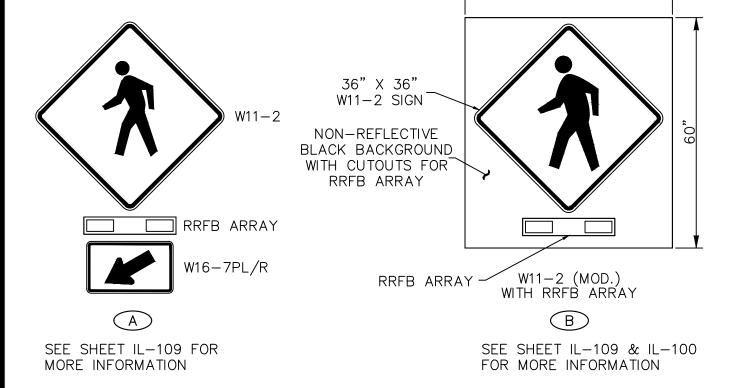

WIRING SCHEDULE						
RUN	CONDUIT SIZE/TYPE	DDD CADLE	ILLUM	GRND	PULL TAPE	COMMENTS
NO.	CONDUIT SIZE/TTPE	PPB CABLE	#8	#8	PULL TAPE	COMMENTS
1	NEW 2"		2	1		
'	NEW 2"			1	1	SPARE
2	NEW 2"			1	1	SPARE
3	NEW 2"		2	1		
4	EX.	1	2 EX.	1		
5	NEW 1"	1		1		
6	NEW 2"	1		1		
0	NEW 2"			1	1	SPARE
7	NEW 2"		2	1		
,	NEW 2"	1		1		
Note 1 O	nly proposed conductors shown					

Note 1. Only proposed conductors shown.

Note 2. Ground wire shall be equal to or larger than largest conductor in conduit.


Note 3. New circuit wiring shall be aluminum. For lights installed on existing circuits, wiring material shall match existing wiring material (copper or aluminum) and shall match existing wiring size. Contractor shall notify engineer if there is a discrepancy between the Wiring Schedule and the field conditions.

Note 4. Conduits installed under travelled way shall be schedule 80. All other conduits shall be schedule 40.

GENERAL NOTES:

1. JUNCTION BOXES INSTALLED OUTSIDE OF THE SIDEWALK SHALL BE SURROUNDED BY A CONCRETE PAD PER CITY OF FEDERAL WAY STANDARD DRAWING 3-39A.

2. NEW POLES WITH LUMINAIRES SHALL BE NUMBERED PER FEDERAL WAY STANDARD DRAWING NUMBER 3-39B.

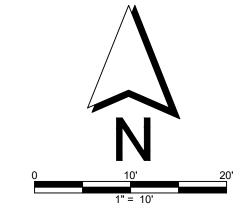

	APN 873179-0000 APN 873179-0000 HL94 OFF: 30.17'L P(US)
HOYT RD SW 00+000	S. 320TH STREET 605+00 606 S. 320TH STREET 607 608 608 S. 320TH STREET
	STA: 605+22.46 OFF: 29.74'R -LIGHT JBOX POWER VAULT TOBY TOBY





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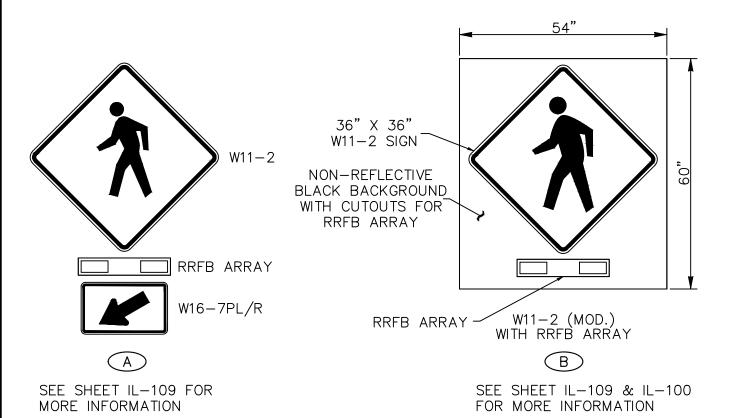
CITY PROJECT # 36234

RRFB SYSTEM LOCATION 6: SW 320TH ST AT 45TH PL SW IL-106


SHEET

- 1) FW RRFB SIGNAL STANDARD POLE WITH SINGLE OR DOUBLE SIDED SOLAR RRFB ASSEMBLY PER PLAN, PER WSDOT IS-22 (SHEET 2 OF 2), AND PER SHEET IL-109.
- 2 REMOVE EXISTING POLE AND FOUNDATION. CAP CONDUITS.
- 3 STANDARD TYPE III MAST ARM POLE PER WSDOT IS-13B AND PER SHEETS IL-109 AND IL-110 WITH SOLAR RRFB ASSEMBLY.
- SIGNAL STANDARD FOUNDATION PER WSDOT J-26.10-03. IF FOUNDATION IS ADJACENT TO CURB, TOP OF FOUNDATION SHALL BE FINISHED FLUSH WITH ADJACENT CURB VERTICALLY AND HORIZONTALLY.
- FW RRFB SIGNAL STANDARD POLE FOUNDATION IN ACCORDANCE WITH THE RRFB FOUNDATION DETAIL ON SHEET IL-110.
- $\overline{\langle 7 \rangle}$ REPLACE EXISTING JUNCTION BOX IN PLACE WITH NEW JUNCTION BOX WITH SLIP RESISTANT LID.
- (8) CONTRACTOR SHALL POTHOLE AND NOTIFY ENGINEER IF CONFLICT EXISTS.
- LIGHT FIXTURE TO BE ADDED BY OTHERS. CONTRACTOR SHALL COORDINATE WITH PSE ON WORK PHASING TO ENSURE LIGHT IS UPGRADED BY THE TIME THE NEW PEDESTRIAN CROSSING IS FUNCTIONING.
- (17) ORIENT POLE SUCH THAT HANDHOLE FACES THE STREET FOR EASE OF ACCESS.
- INSTALL PEDESTRIAN PUSH BUTTON POST AND PUSH BUTTON PER WSDOT STANDARD PLAN J-20.10-04 WITH CURB BASE FOUNDATION PER WSDOT STANDARD PLAN J-20.11-03.
- $\langle 21 \rangle$ Splice New and existing lighting conductors for New Street light added to existing circuit.
- CONTRACTOR SHALL INVESTIGATE SIDEWALK BASE. CONTRACTOR SHALL REPORT FIELD CONDITIONS TO ENGINEER TO VERIFY THAT CURRENT DESIGN IS ACCEPTABLE BEFORE STARTING WORK.

LEGEND:	PROPOSED
STREET LIGHT	•
MAST ARM POLE	O .
FW RRFB POLE	
PED PUSH BUTTON	4
CONSTRUCTION NOTE	1
WIRE NOTE	1
UNDERGROUND CONDUIT	
TYPE 1 JB	lacktriangle
TYPE 2 JB	
SERVICE ENCLOSURE	
OVERHEAD RRFB/SIGN	
POST MOUNTED RRFB/SIGNS	<u> </u>





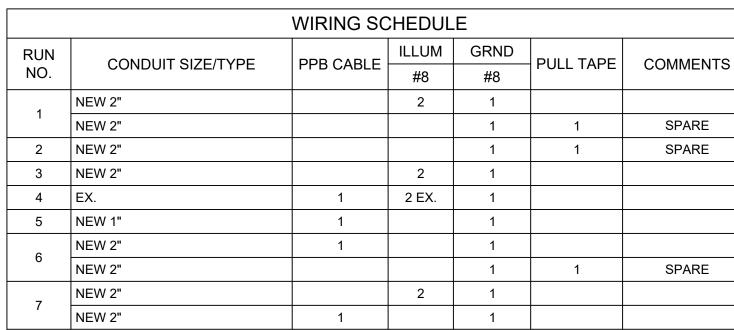

Note 1. Only proposed conductors shown.

Note 2. Ground wire shall be equal to or larger than largest conductor in conduit.


Note 3. New circuit wiring shall be aluminum. For lights installed on existing circuits, wiring material shall match existing wiring material (copper or aluminum) and shall match existing wiring size. Contractor shall notify engineer if there is a discrepancy between the Wiring Schedule and the field conditions.

Note 4. Conduits installed under travelled way shall be schedule 80. All other conduits shall be schedule 40.

GENERAL NOTES:

1. JUNCTION BOXES INSTALLED OUTSIDE OF THE SIDEWALK SHALL BE SURROUNDED BY A CONCRETE PAD PER CITY OF FEDERAL WAY STANDARD DRAWING 3—39A.

2. NEW POLES WITH LUMINAIRES SHALL BE NUMBERED PER FEDERAL WAY STANDARD DRAWING NUMBER 3-39B.

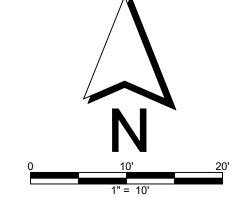

Note 4. Conduits installed under travelled way shall be scriedule 30. All other conduits shall be scriedule 40.	
APN 926975-0390 SHELLEY SPRINGER	APN 252103-9034 NICHOLAS EMSWILER POWER POLE W/UNDERGROUND P(UG) P(UG) P(UG) P(UG) P(UG)
\$\frac{1}{22}\frac{17}{6}\$	15 w _ w _ w _ w _ w _ w _ w _ w _ w _ w _
SW. 356TH AVENUE	
SD -	SD



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RRFB SYSTEM
LOCATION 7: SW 356TH ST AT 18TH AVE SW

CITYWIDE PEDESTRIAN SAFETY

SHEET


IL-107

CITY PROJECT #

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- (1) FW RRFB SIGNAL STANDARD POLE WITH SINGLE OR DOUBLE SIDED SOLAR RRFB ASSEMBLY PER PLAN, PER WSDOT IS-22 (SHEET 2 OF 2), AND PER SHEET IL-109.
- 3 STANDARD TYPE III MAST ARM POLE PER WSDOT IS-13B AND PER SHEETS IL-109 AND IL-110 WITH SOLAR RRFB
- SIGNAL STANDARD FOUNDATION PER WSDOT J-26.10-03. IF FOUNDATION IS ADJACENT TO CURB, TOP OF FOUNDATION SHALL BE FINISHED FLUSH WITH ADJACENT CURB VERTICALLY AND HORIZONTALLY.
- FW RRFB SIGNAL STANDARD POLE FOUNDATION IN ACCORDANCE WITH THE RRFB FOUNDATION DETAIL ON SHEET IL-110.
- $\overline{\langle 11 \rangle}$ install new junction box with SLIP resistant Lid.
- (23) INSTALL NEW SERVICE ENCLOSURE PER SPECIFICATIONS. CONTRACTOR SHALL VERIFY LOCATION OF SERVICE ENCLOSURE WITH ENGINEER PRIOR TO INSTALLATION.
- INSTALL CONDUIT AND WIRING TO NEW SERVICE POINT PER SPECIAL PROVISIONS. LOCATION OF SERVICE POINT SHALL BE VERIFIED WITH THE ENGINEER AND TACOMA PUBLIC UTILITIES.
- $\langle 25 \rangle$ Install pedestrian push button post and push button per wsdot standard plan j-20.10-04.
- (26) NEW CONDUIT SHALL BE INSTALLED USING DIRECTIONAL BORING.

LEGEND:	PROPOSED
STREET LIGHT	•
MAST ARM POLE	
FW RRFB POLE	
PED PUSH BUTTON	4
CONSTRUCTION NOTE	$\langle 1 \rangle$
WIRE NOTE	1
UNDERGROUND CONDUIT	
TYPE 1 JB	
TYPE 2 JB	
SERVICE ENCLOSURE	
OVERHEAD RRFB/SIGN	
POST MOUNTED RRFB/SIGNS	

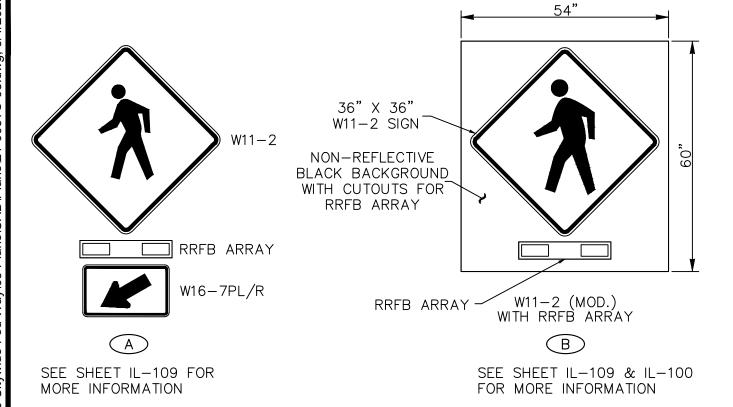

		WIRING SC	HEDUL	.E		
RUN	CONDUIT SIZE/TYPE	PPB CABLE	ILLUM	GRND	PULL TAPE	COMMENTS
NO.	CONDUIT SIZE/TTPE	PPB CABLE	#8	#8	TOLL TAPE	COMMENTS
1	NEW 2"		2	1		
ı	NEW 2"			1	1	SPARE
2	NEW 2"			1	1	SPARE
3	NEW 2"		2	1		
4	EX.	1	2 EX.	1		
5	NEW 1"	1		1		
6	NEW 2"	1		1		
O	NEW 2"			1	1	SPARE
7	NEW 2"		2	1		
7	NEW 2"	1		1		


Note 2. Ground wire shall be equal to or larger than largest conductor in conduit.

Note 3. New circuit wiring shall be aluminum. For lights installed on existing circuits, wiring material shall match existing wiring material (copper or aluminum) and shall match existing wiring size. Contractor shall notify engineer if there is a discrepancy between the Wiring Schedule and the field conditions.



1. JUNCTION BOXES INSTALLED OUTSIDE OF THE SIDEWALK SHALL BE SURROUNDED BY A CONCRETE PAD PER CITY OF FEDERAL WAY STANDARD DRAWING 3-39A.

2. NEW POLES WITH LUMINAIRES SHALL BE NUMBERED PER FEDERAL WAY STANDARD DRAWING NUMBER 3-39B.

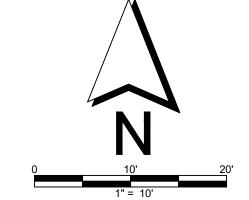

	between the Wiring Schedule and the field conditions.			
	Note 4. Conduits installed under travelled way shall be schedule 80. All	other conduits shall be schedule 40.	1	
			SW S	
	APN 252	2103-9016		
	MICHAE	L MUSICA	AVENUE	A
				3\
			73BD (11)	
		≥ = = = = = = = = = = = = = = = = = = =	- M P(0)	
		⇒ SD — SD	sD -	(25)
		 	P(0H) —	SD SD SD
w			P(0)	B
	- w - w - w - w - w - w - w - w - w - w	W W W - W - W - W - W - W - W - W -	- w — w — w — w — w — w — w	w —
		***	P(OH) -	
		*	W(REF)	SW 356TH AVE
		 	(REF)—V	
			P(OH)	
)	29TH ST NE		804+00	
			REH) B	
			26) 1 P(OH)	
•	31.3* CURB DROP		WATER VALVE - WE BLOW-OFF	
T(UG)	T(UG) — T(UG) — T(UG) — T(UG) — T(UG) — T(UG) — T(UG)	T(UG) T(UG) T(UG) T(UG) T(UG) T(UG)	6"DEC.	
— G — G — G — G —	- c - c - c - c - c - c - c - c - c - c		T(UG) T(UG) P(G)	
- P(94)	P(OH) — P(OH) > S(OH)	G = G = G = G = G = G = G = G = G = G =	- c - c - c - c - c - 2 c - 2	3 — G — G — d —
	P(OH) — P(OH) — P(OH) — P(OH) WN	P(OH) — P(OH) — P(OH) — P(OH)	(PI)	(D)
	/ Power po W/Lumina	DLE 10"DEC/	11)	1 6 POWER POLE
			23 24	W/GUY WIRES





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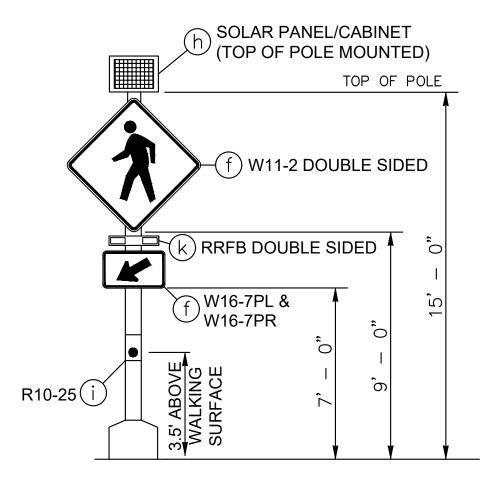
RRFB SYSTEM LOCATION 8: SW 356TH ST AT 23RD AVE SW

SHEET IL-108


CITY PROJECT #

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SIGN SPECIFICATIONS									
SIGN	SIZE BY APPRO	ACHING LANES	SHEETING	SIGN COLOR					
CODE	SINGLE LANE	MULTI-LANE	TYPE	SIGN COLOR					
W11-2 (MOD.)	54" >	k 60"	IX	SEE SHEET IL-110					
W11-2	30" x 30"	36" x 36"							
W16-7PL	24" x 12"	24" x 12"	IX	FLUORESCENT YELLOW GREEN					
W16-9P	24" x 12"	24" x 12"							



FW RRFB SIGNAL STANDARD WITH DOUBLE SIDED SOLAR RRFB ASSEMBLY

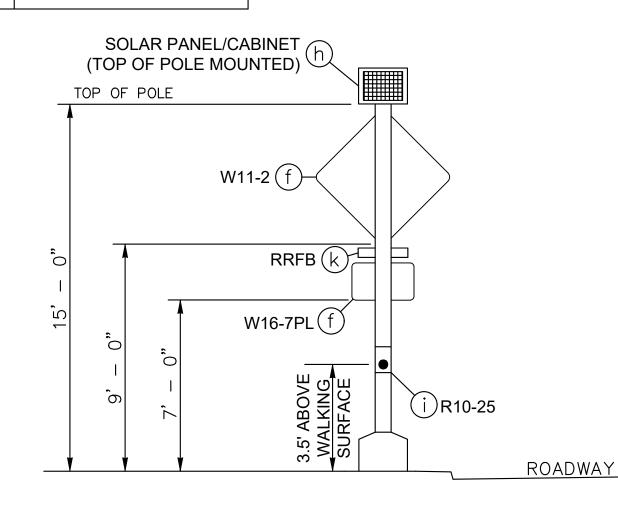

FW RRFB SIGNAL STANDARD WITH SINGLE SIDED SOLAR RRFB ASSEMBLY (FACING AWAY)

POLE ORIENTATION AND E1 ATTACHMENT POINT DETAIL W11-2 (MOD.) W11-2 (MOD.) SOLAR PANEL/CABINET (SIDE OF POLE MOUNTED) **VERTICAL** BOTTOM OF SOLAR PANEL CLEARANCE: 16' - 6" MIN. 19' - 0" MAX. **EQUIPMENT LEGEND** (18' MIN. **TYPE** 20' MAX.) () RRFB SIGN ASSEMBLY - ARM MOUNT **SIGN - POLE MOUNT** SOLAR PANEL/CABINET (f)W16-7PL PUSHBUTTON & SIGN 8 & 9 HANDHOLE)R10-25 RRFB LED BAR - POLE MOUNT **ELEVATION IS TO** TOP OF FOUNDATION CURB OR EDGE OF SHOULDER ROADWAY LIMITS OF VERTICAL CLEARANCE NOTE 13 **WSDOT TYPE II SIGNAL STANDARD** NOTE 12 WITH RRFB ASSEMBLY & MODIFIED W11-2 SIGNS

EQUIPMENT OFFSETS AND

ATTACHMENT ANGLES

W11-2 (MOD.) ASSEMBLIES

SHOWN HERE WITH RRFBs

COMBINED DETAIL FOR RRFB LOCATIONS WITH MAST ARM & POLE CONFIGURATION

									SIGNAL	STANDAR	D DETAIL	CHART										
LOCATION			FIELD LOCATION				MOUNTING HEIGHT	MOUNTING HEIGHT			T ARM DATA	REAS (FT ²) (X)(Y)	ARM	CALCULATED POLE		ATTACHMEN OINT ANGL	ES	FOUNDATION DESIGN	BEARING		DATION TH (FT)	REMARKS
#	LOCATION INFO	STATION	OFFSET (FT) LT.	l	P.O.A. EGREES)		(FT) A1	(FT)	(POLE' TO ATTA	S (FT) (Z) ACHMENT POINT) B2	B1	B2	(FT)	XYZ (FT³)	E	(DEGREES	PPB	XYZ (FT ⁻)	PRESSURE (PSF)	3' RD.	3' SQ.	- NEWARKS
1	S 320TH ST - 1400 BLOCK	119+34.68	38.47 X		0	Ш	19	35	54.5	21	22.5	22.5	10	1710	0	270	90	1900	4500	9	7	
3	S 312TH ST AT 18TH AVE S	301+27.43	30.91	X	0	II	19	NA	48	14	22.5	22.5	10	1415	0	270	NA	1500	4500	8	6	
4	336TH ST AT 10TH PL S	401+11.38	40.32	X	0	Ш	19	35	51	18	22.5	22.5	10	1565	0	270	90	1900	2300	13	8	
6	SW 320TH ST AT 45TH AVE PL	605+14.48	38.06 X		0	III	19	35	53	23	22.5	22.5	10	1730	0	270	90	1900	2700	9		HANDHOLE SHALL BE ORIENTED ON SIDE OF POLE RATHER THAN BACK OF POLE. ATTACHMENT POINT ANGLE 270 DEGREES.
7	SW 356TH ST AT 18TH AVE SW	701+19.07	42.11	X	0	Ш	19	35	59	25	22.5	22.5	10	1890	0	270	NA	1900	2900	9	7	
8	SW 356TH ST AT 23RD AVE SW	804+30.69	47.24 X		0	III	19	35	57	22	22.5	22.5	12	1780	0	270	NA	1900	2500	12	10	



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RRFB SYSTEM DETAIL SHEET CITY PROJECT # 36234

POLE ORIENTATION ANGLE (P.O.A.) ~

SEE NOTE 2


LOCATION STATION

IL-109

SHEET

NOTES:


- 1) CLAMPING BOLTS SHALL BE TIGHTENED TO 50 FT-LBS MAX TORQUE. DO NOT OVER TIGHTEN.
- 2) SUPPLEMENTAL GROUNDING CONDUCTOR SHALL BE NON-INSULATED #4 AWG STRANDED COPPER, PROVIDE 3 FT. MINIMUM SLACK. CLAMP TO VERTICAL STEEL REINFORCING BAR WITH LISTED CONNECTOR SUITABLE FOR USE EMBEDDED IN CONCRETE.
- 3) JUNCTION BOX SERVING THE STANDARD SHALL PREFERABLY BE LOCATED 5 FT. FROM THE STANDARD (10 FT. MAXIMUM).
- 4) EQUIPMENT GROUNDING CONDUCTOR SHALL ATTACH TO GROUNDING LUG WITH A FULL CIRCLE CRIMP-ON CONNECTOR (CRIMPED WITH A MANUFACTURER-RECOMMENDED CRIMPER).
- 5) HAND HOLE/DOOR LOCATED AT 180 DEGREES FROM MAJOR ROADWAY, UNLESS OTHERWISE SPECIFIED.
- 6) FOUNDATION MAY BE CONSTRUCTED USING METHOD 1 OR METHOD 2, UNLESS OTHERWISE SHOWN IN THE PLANS. FULL-DEPTH PAPERBOARD FORM IS NOT ALLOWED. SEE CURRENT WSDOT STANDARD PLAN
- 7) WEEP HOLE TO BE PLACED ON DOWNHILL SIDE OF FOUNDATION.
- * CONTRACTOR IS RESPONSIBLE FOR VERIFYING BELOW DIMENSIONS, AFTER CITY OF FEDERAL WAY APPROVAL OF SHOP DRAWINGS AND PRIOR TO ANCHOR BOLT INSTALLATION ..

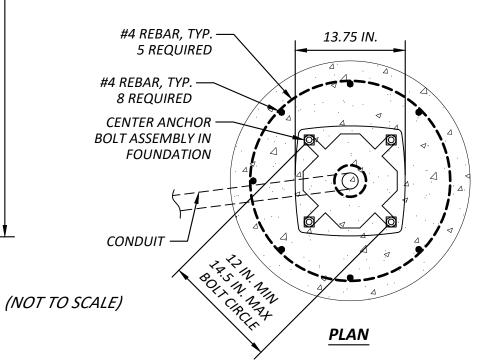


INSTALLED IN SIDEWALK AREA*	

	ANCHOR BOLT Ø
ASSUMPTIONS	0.75 IN. Ø BOLT
TOP THREADS	0.5 - 1.0 IN.
NUT HEIGHT X 2	1.5 IN.
WASHER X 2	0.5 IN.
BASE	0.5 IN.
LEVELING THREADS	1.0 IN.
SIDEWALK DEPTH	6.0 IN.
Y	10 - 11.5 IN.

GROUT PAD HEIGHT SHALL BE 1.0 - 2.5 IN.

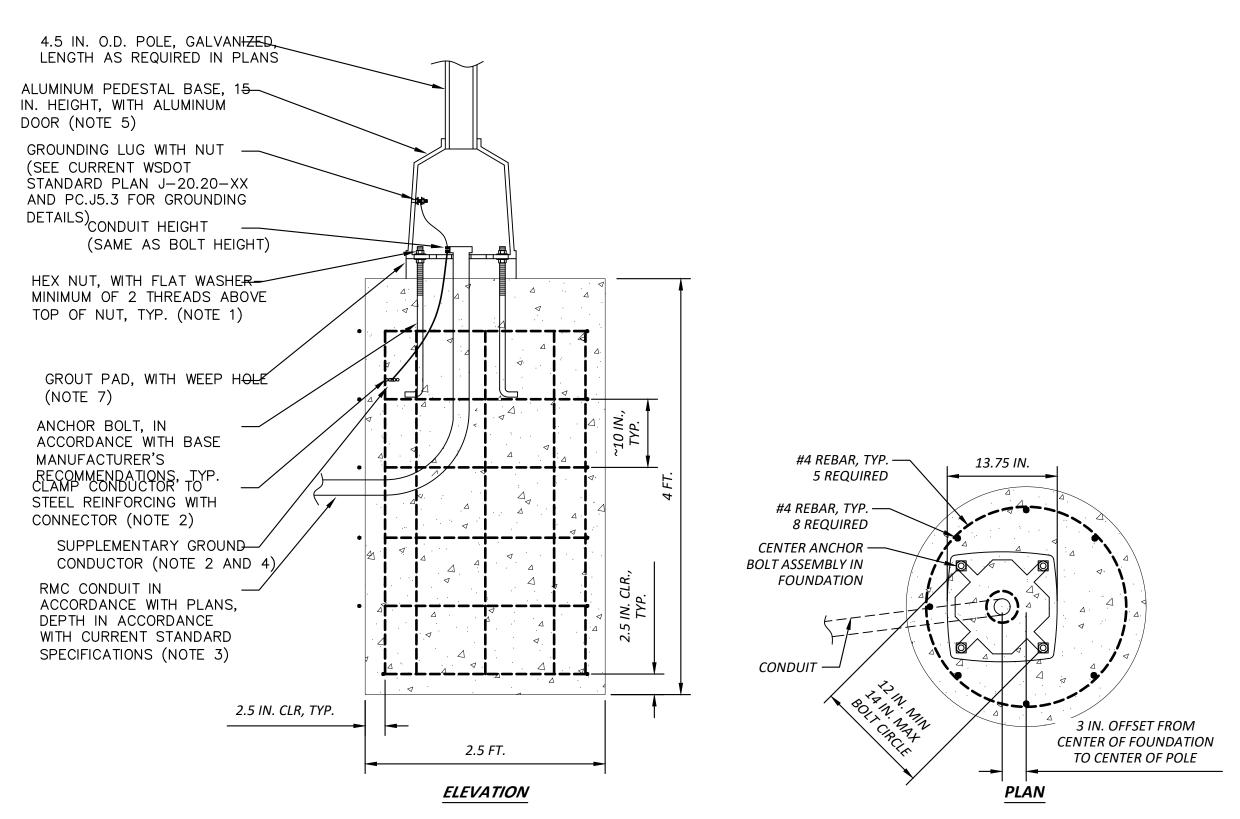

RRFB CURB FOUNDATION DETAIL

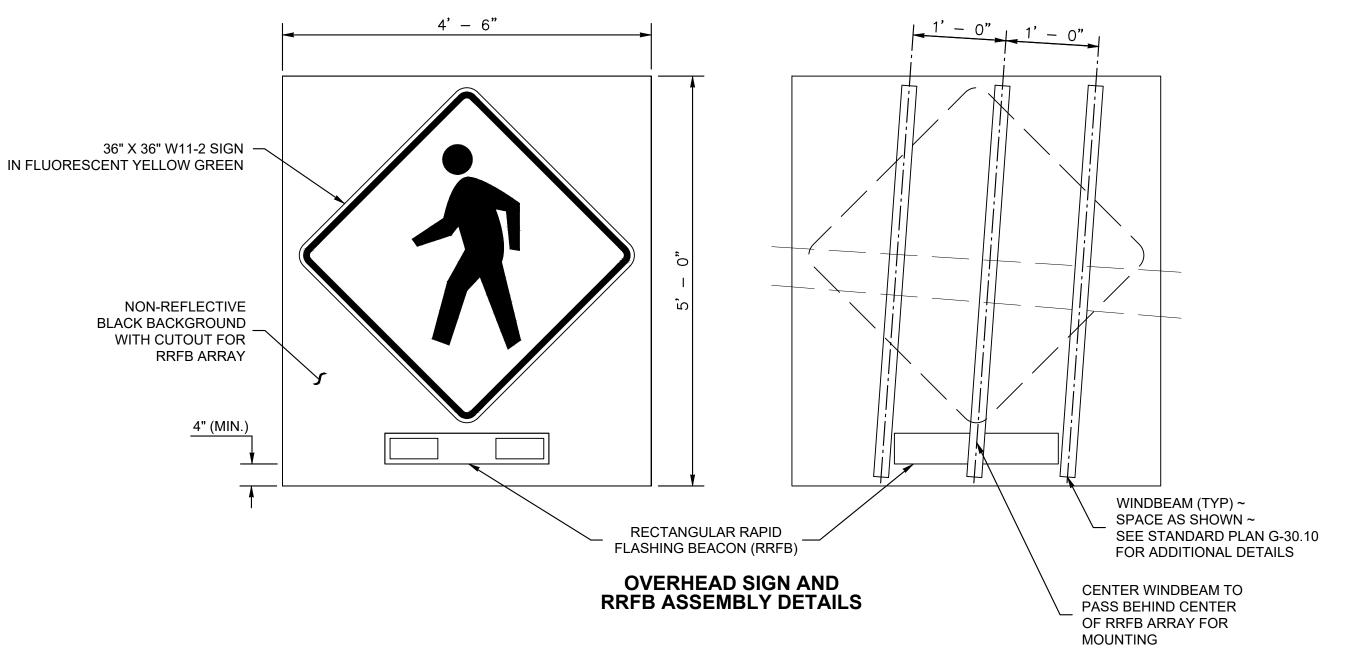

RRFB SYSTEM NOTES:

- 1. MAST ARMS SHALL NOT HAVE TENONS INSTALLED. WIRING ACCESS FOR RRFBs SHALL BE FIELD DRILLED AND USE RUBBER GROMMETS AND DRIP LOOPS.
- 2. POLE ORIENTATION ANGLE IS MEASURED BETWEEN STATION OFFSET LINE AND THE CENTER OF THE BASEPLATE FRONT. THE POLE HANDHOLE IS ALWAYS AT THE BACK OF THE BASEPLATE (180° ON BASEPLATE).
- 3 STREET NAME SIGNS SHALL NOT BE INSTALLED ON THE SIGNAL STANDARDS.
- 4. **B1** AND **B2** SHALL BE CENTERED OVER THEIR RESPECTIVE APPROACH THROUGH
- 5. RRFB LED BARS SHALL CONFORM TO THE LATEST MUTCD REQUIREMENTS. RRFB LED BARS SHALL HAVE SIDE CONFIRMATION LIGHTS. SEE SPECIAL PROVISIONS.
- 6. SOLAR POWERED RRFBs SHALL BE AN ALL-IN-ONE SOLAR PANEL & TERMINAL CABINET SYSTEM THAT CAN OPERATE UP TO 3 LED BARS AND A PUSHBUTTON SIMULTANEOUSLY.
- 7. SEE **STANDARD PLAN G-30.14** FOR SIGN MOUNTING DETAILS. MAST ARM MOUNTED SIGNS SHALL USE A MINIMUM OF THREE WINDBEAMS. SEE SIGN SPECIFICATION TABLE FOR SIGN SIZES AND SHEETING.
- 8. PUSHBUTTON ASSEMBLIES SHALL BE AS SHOWN ON PLANS, ORIENTED RELATIVE TO THE CROSSWALK AND LEVEL CLEAR SPACE.
- 9. PUSHBUTTON SHALL BE VOICE CAPABLE AND MEET THE LATEST MUTCD RRFB PUSHBUTTON REQUIREMENTS.
- 10. POLE MOUNTED DISPLAYS AND SIGNS SHALL BE FIELD ORIENTED TOWARDS APPROACHING TRAFFIC, AND MUST BE 2' - 0" MIN. FROM FACE OF CURB OR EDGE
- 11. CENTER OF BUTTON SHALL BE 3' 6" AS MEASURED FROM THE WALKING SURFACE.
- 12. FACE OF POLE MUST BE SET BACK AS FOLLOWS:

a. 2' - 0" MIN. FROM FACE OF CURB OR EDGE OF SHOULDER.



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DRAFTED: ER DESIGNED: MT REVIEWED: PP

APPROVED:

RRFB FOUNDATION DETAIL

PH CONSULTING

DRAWING VERSION / REVISION LOG NO. DATE REVISION

CITYWIDE PEDESTRIAN SAFETY

DETAIL SHEET

RRFB SYSTEM

IL-110

37 of 37

CITY PROJECT #

36234

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